


12/20/93
 12/20/93
 12/20/93
 12/20/93
 Take

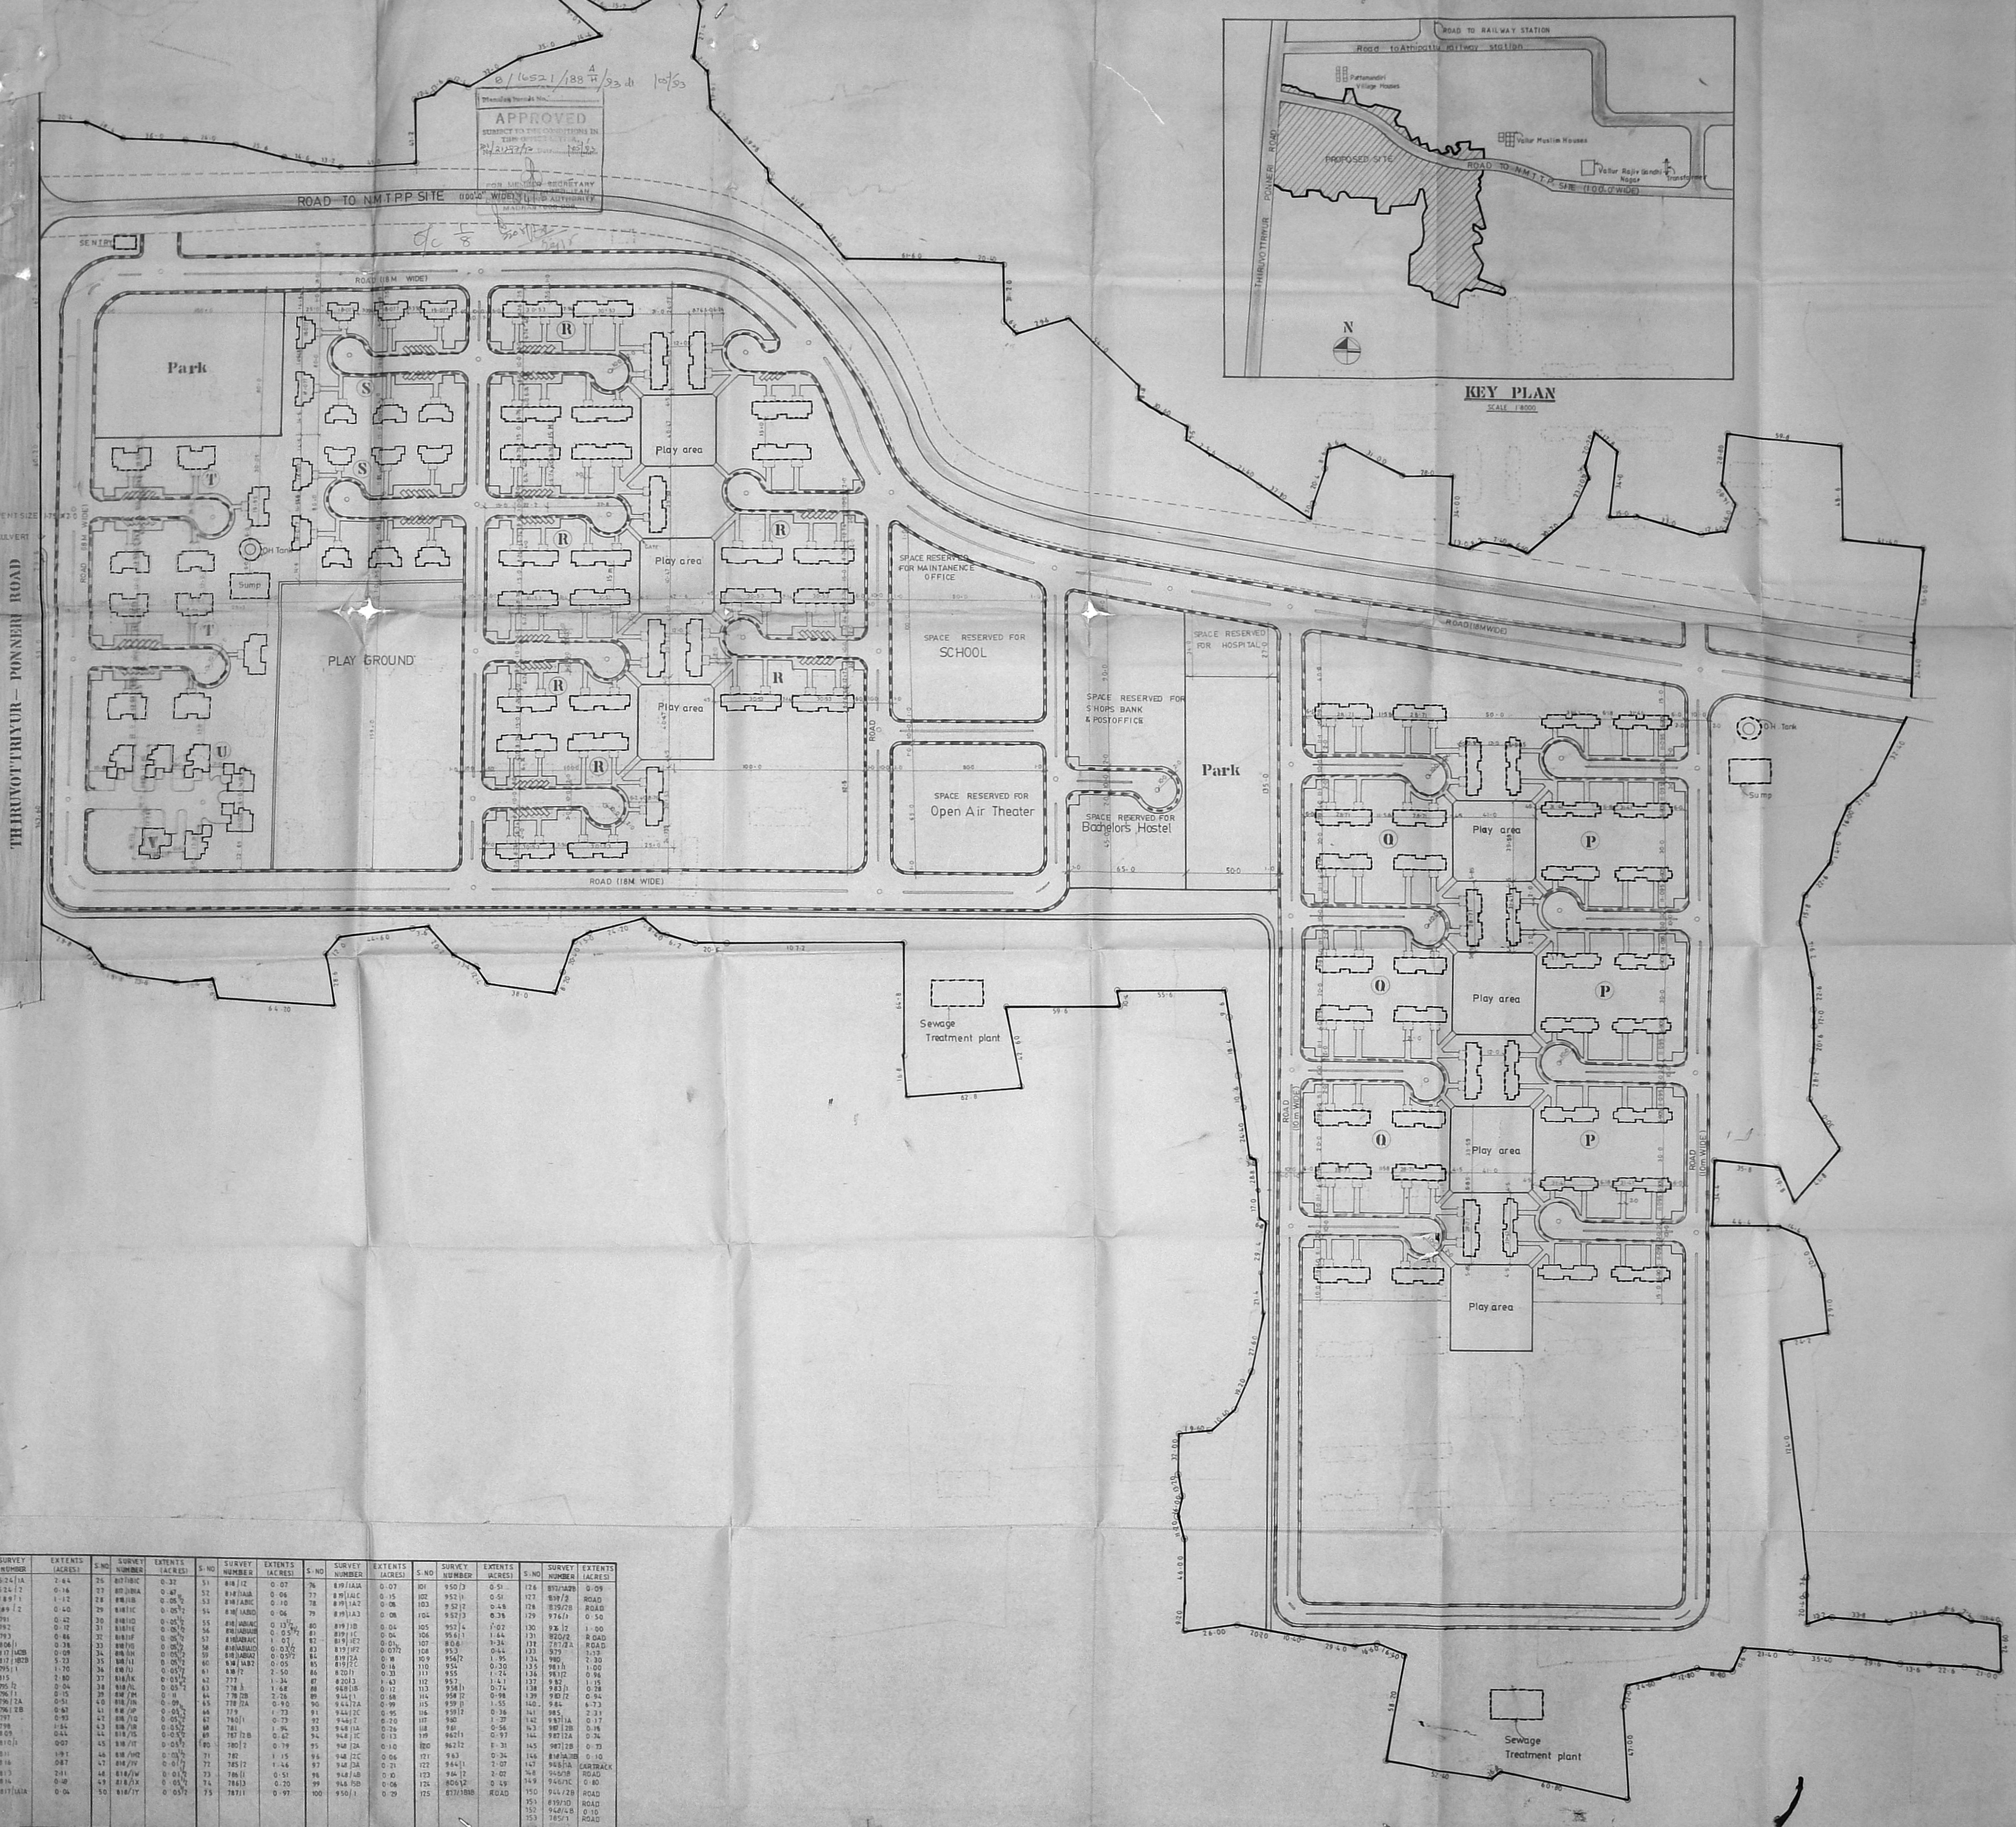

S. NO.	SURVEY NUMBER	EXTENTS (ACRES)	S. NO.	SURVEY NUMBER	EXTENTS (ACRES)	S. NO.	SURVEY NUMBER	EXTENTS (ACRES)	S. NO.	SURVEY NUMBER	EXTENTS (ACRES)	S. NO.	SURVEY NUMBER	EXTENTS (ACRES)
1	524/1A	2.64	25	807/10C	0.33	51	818/12	0.07	76	897/1A	0.07	80	950/2	0.51
2	524/2	0.16	27	807/10A	0.49	52	818/11A	0.06	77	897/1A	0.15	81	951/1	0.51
3	189/1	1.12	28	807/10B	0.05	53	818/11B	0.10	78	897/1A	0.08	82	952/2	0.58
4	289/2	0.40	29	818/1C	0.05	54	818/11C	0.06	79	897/1A	0.08	105	952/3	0.38
5	791	0.52	30	818/1D	0.05	55	818/11D	0.13	80	897/1B	0.04	106	953/4	1.02
6	792	0.12	31	818/1E	0.05	56	818/11E	0.05	81	897/1C	0.04	107	954/1	1.84
7	793	0.86	32	818/1F	0.05	57	818/11F	0.01	82	897/1D	0.05	108	955/2	0.44
8	806/1	0.78	33	818/1G	0.05	58	818/11G	0.03	83	897/1E	0.07	109	956/2	1.35
9	817/1A	0.09	34	818/1H	0.05	59	818/11H	0.07	84	897/1F	0.08	110	957	0.30
10	817/1B	5.23	35	818/1I	0.05	60	818/11I	0.05	85	897/1G	0.05	111	958	1.24
11	795/1	1.70	36	818/1J	0.05	61	818/11J	2.50	86	820/1	0.20	112	959	1.61
12	815	2.80	37	818/1K	0.05	62	777	1.34	87	820/2	1.43	113	960	1.37
13	795/2	0.04	38	818/1L	0.05	63	778/3	1.68	88	820/3	0.12	114	961	0.98
14	795/3	0.15	39	818/1M	0.11	64	778/2B	2.78	89	820/4	0.88	115	962	1.39
15	796/2A	0.51	40	818/1N	0.09	65	778/2A	0.90	90	844/2A	0.99	116	963	1.55
16	796/2B	0.80	41	818/1O	0.05	66	779	1.79	91	844/2C	0.95	117	964	0.38
17	797	0.93	42	818/1P	0.05	67	780/1	0.75	92	844/2D	0.20	118	965	1.27
18	798	1.65	43	818/1Q	0.05	68	781	1.95	93	844/2E	0.26	119	966	0.56
19	809	0.44	44	818/1R	0.05	69	782/1B	0.42	94	844/2F	0.13	120	967	1.44
20	810/1	0.07	45	818/1S	0.05	70	780/2	0.79	95	844/2G	0.10	121	968	1.31
21	811	1.97	46	818/1T	0.05	71	782	1.15	96	844/2H	0.06	122	969	0.24
22	818	0.87	47	818/1U	0.10	72	785/2	1.46	97	844/2I	0.21	123	970	2.07
23	813	2.11	48	818/1V	0.10	73	786/1	0.51	98	844/2J	0.20	124	971	1.42
24	814	0.40	49	818/1X	0.05	74	788/3	0.20	99	844/2K	0.06	125	972	2.02
25	817/1A	0.04	50	818/1Y	0.05	75	787/1	0.97	100	950/1	0.29	126	973	0.49

Legend
 PROPOSED CONSTRUCTION SHOWN THIS
 PROPOSED ROAD
 BOUNDARY LINE
 ROADS

LD-01
 DATE 05-07-93
 RDATE 02-02-93

Owner
 S. Subramaniam M. Arch., A.I.A.

Architect
 S. Subramaniam M. Arch., A.I.A.

Architect & Interior designer.
 Licensed Class I, Surveyor No. 90,
 87 Vidyanagar II Main Road,
 Kasturba Nagar, Adyar

Job Title
 PROPOSED HOUSING LAYOUT FOR
 T.N.E.B. NORTH MADRAS THERMAL
 POWER PROJECT AT VALLUR
 VILLAGE NO-144 PONNER TALUK
 CHENNAI M.G.R. DISTRICT


B/16521/188 H/93 dt. 10/6/53

Planning Permit No.....


APPROVED

SUBJECT TO THE CONDITIONS IN THIS OFFICE LETTER No. 1/1227/32 Date 10/6/53



FOR MEMBER SECRETARY
MADRAS METROPOLITAN
DEVELOPMENT AUTHORITY
MADRAS-600008.

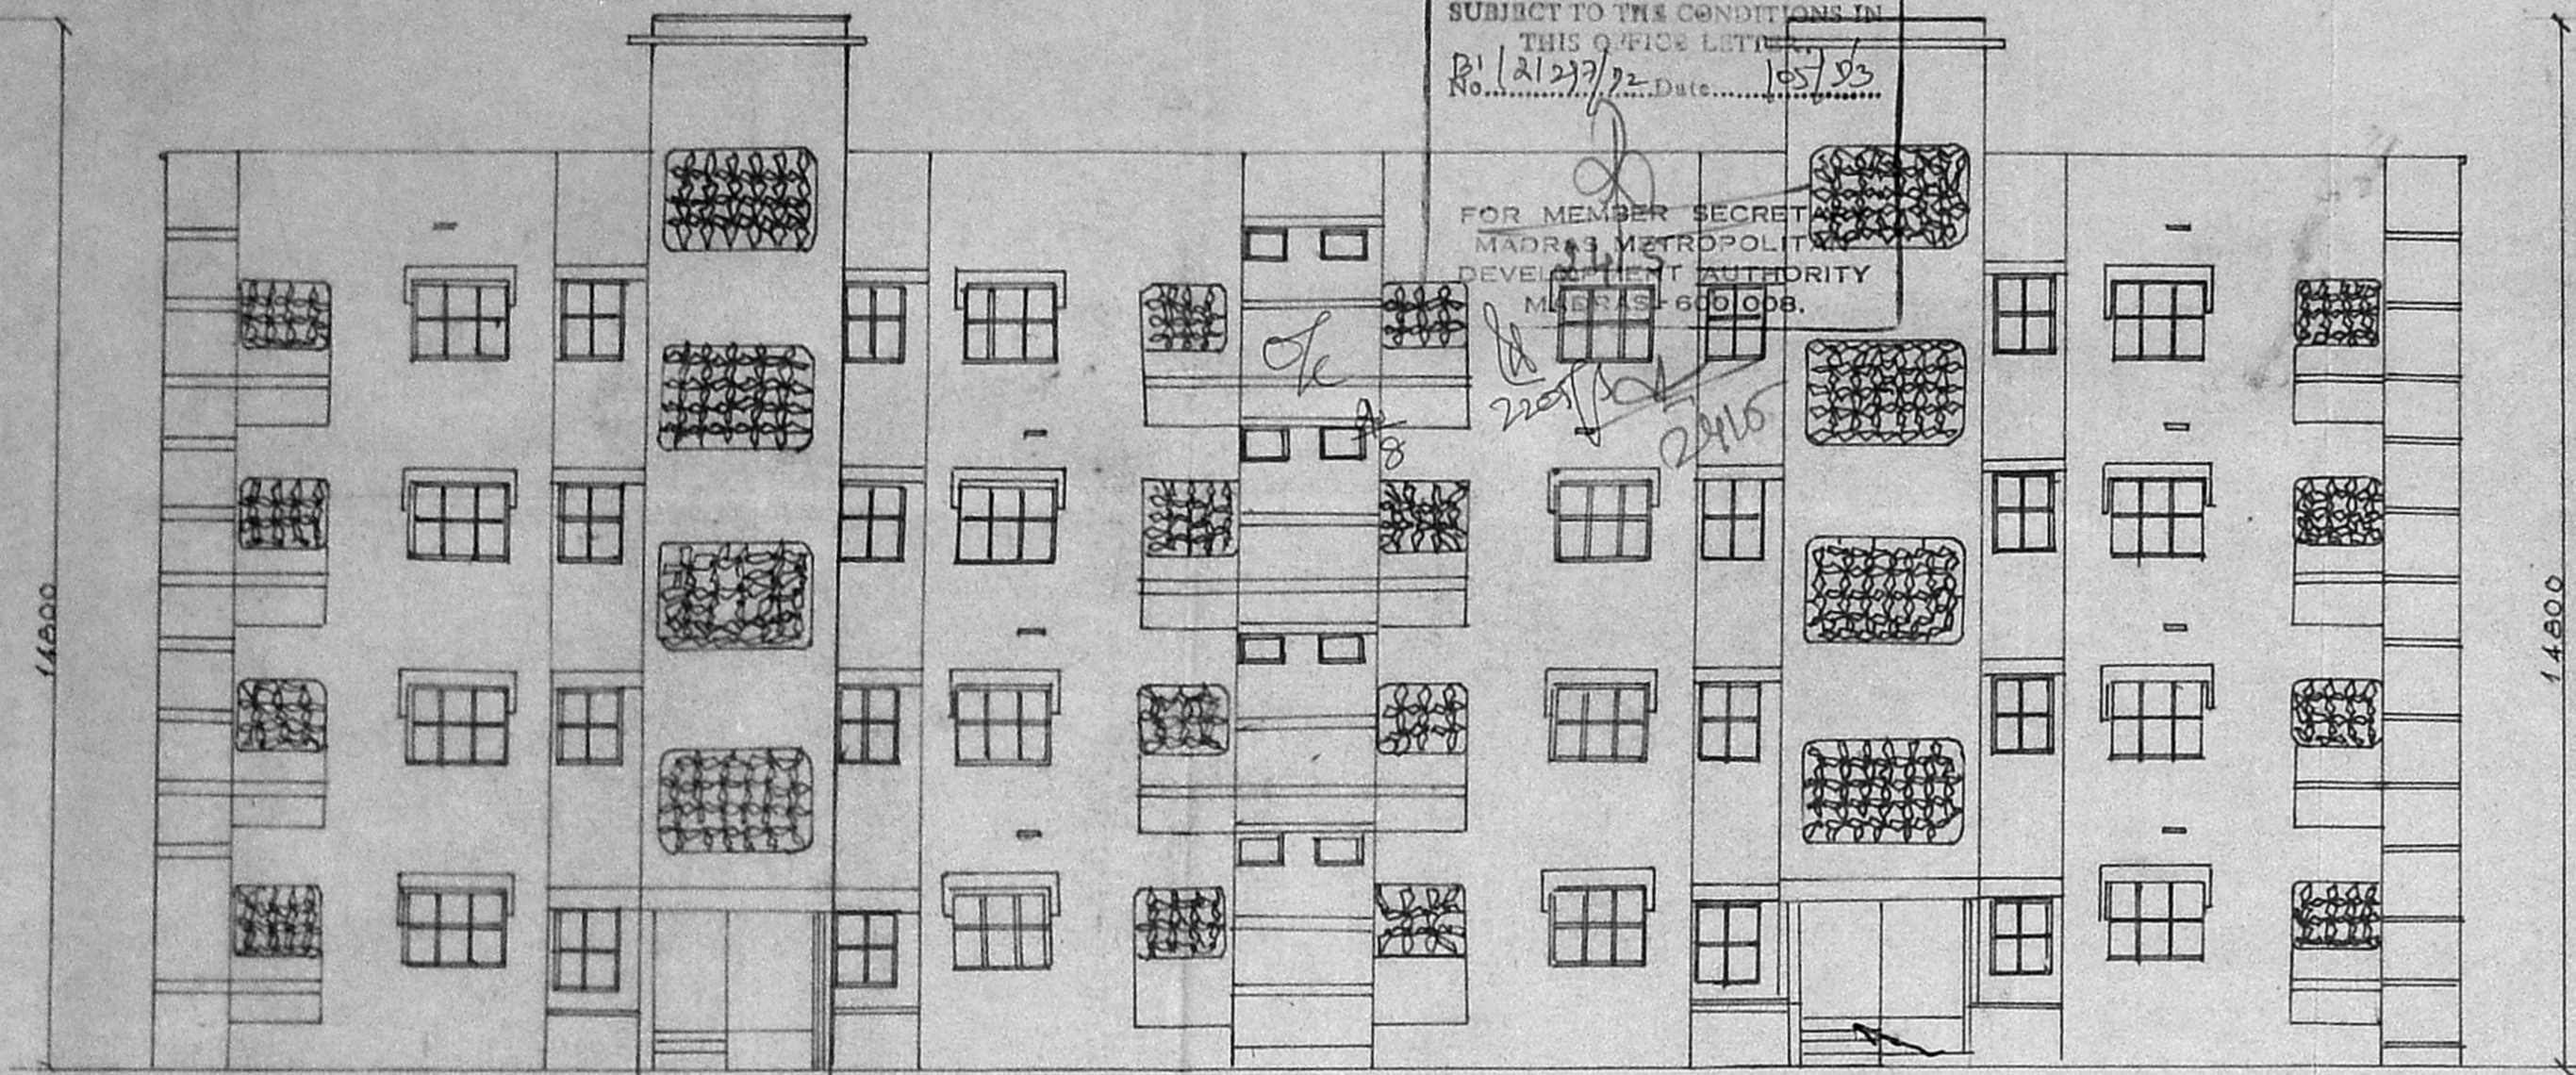

ELEVATION

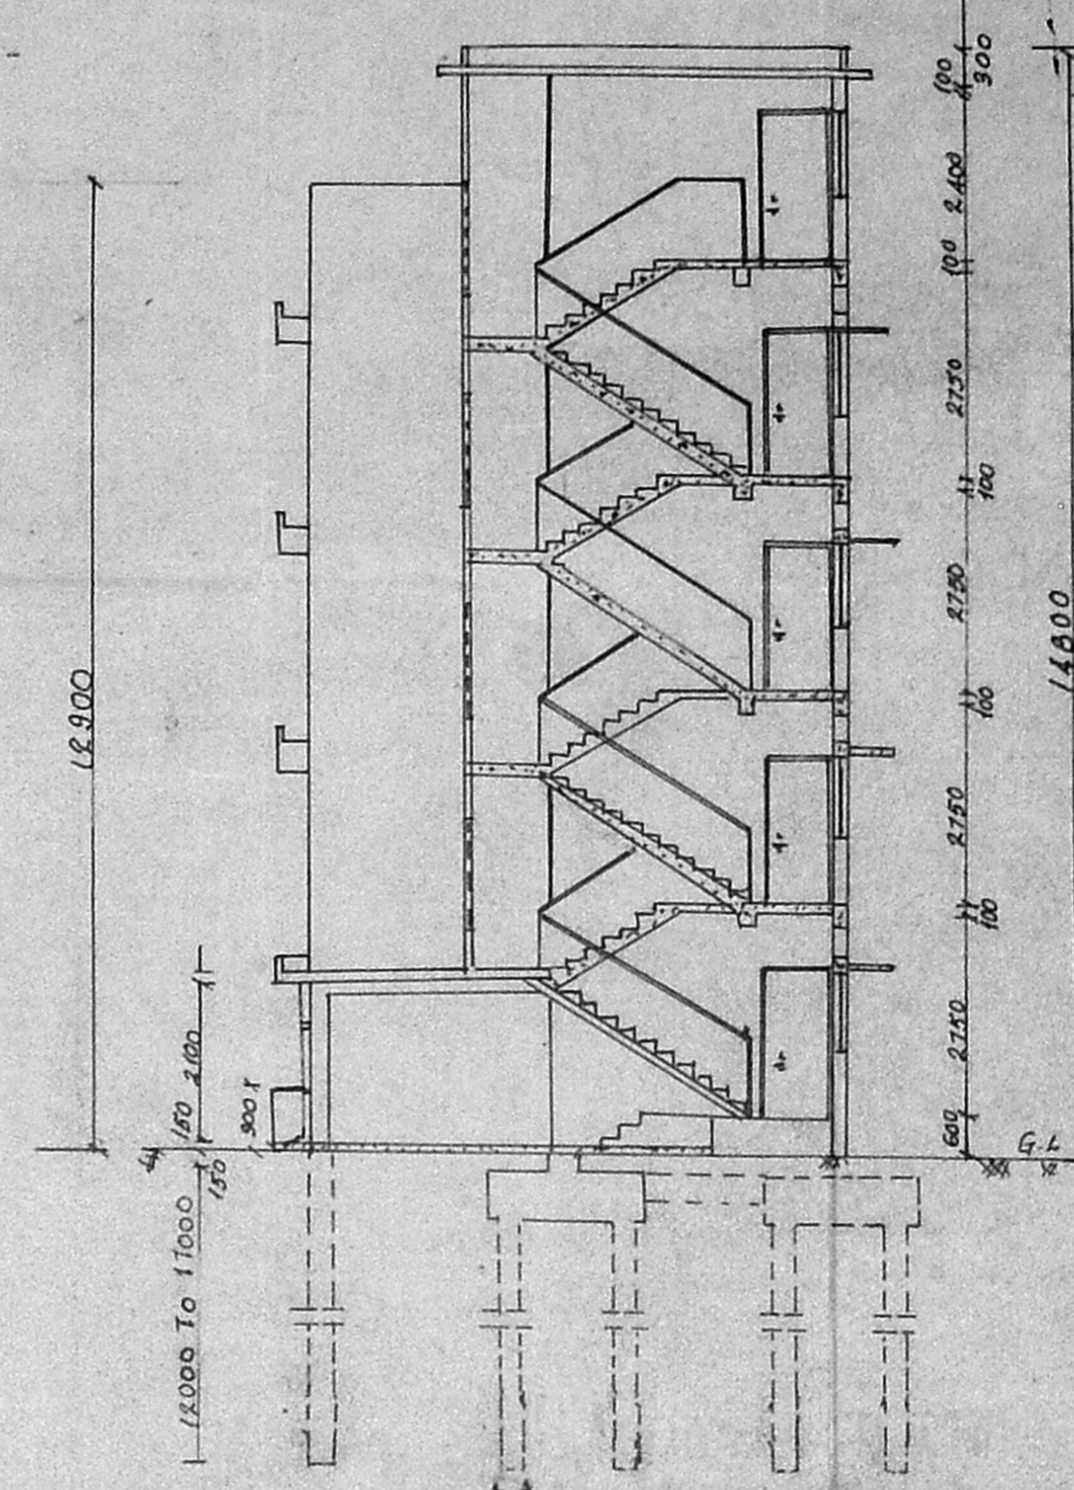

SECTION ON AB

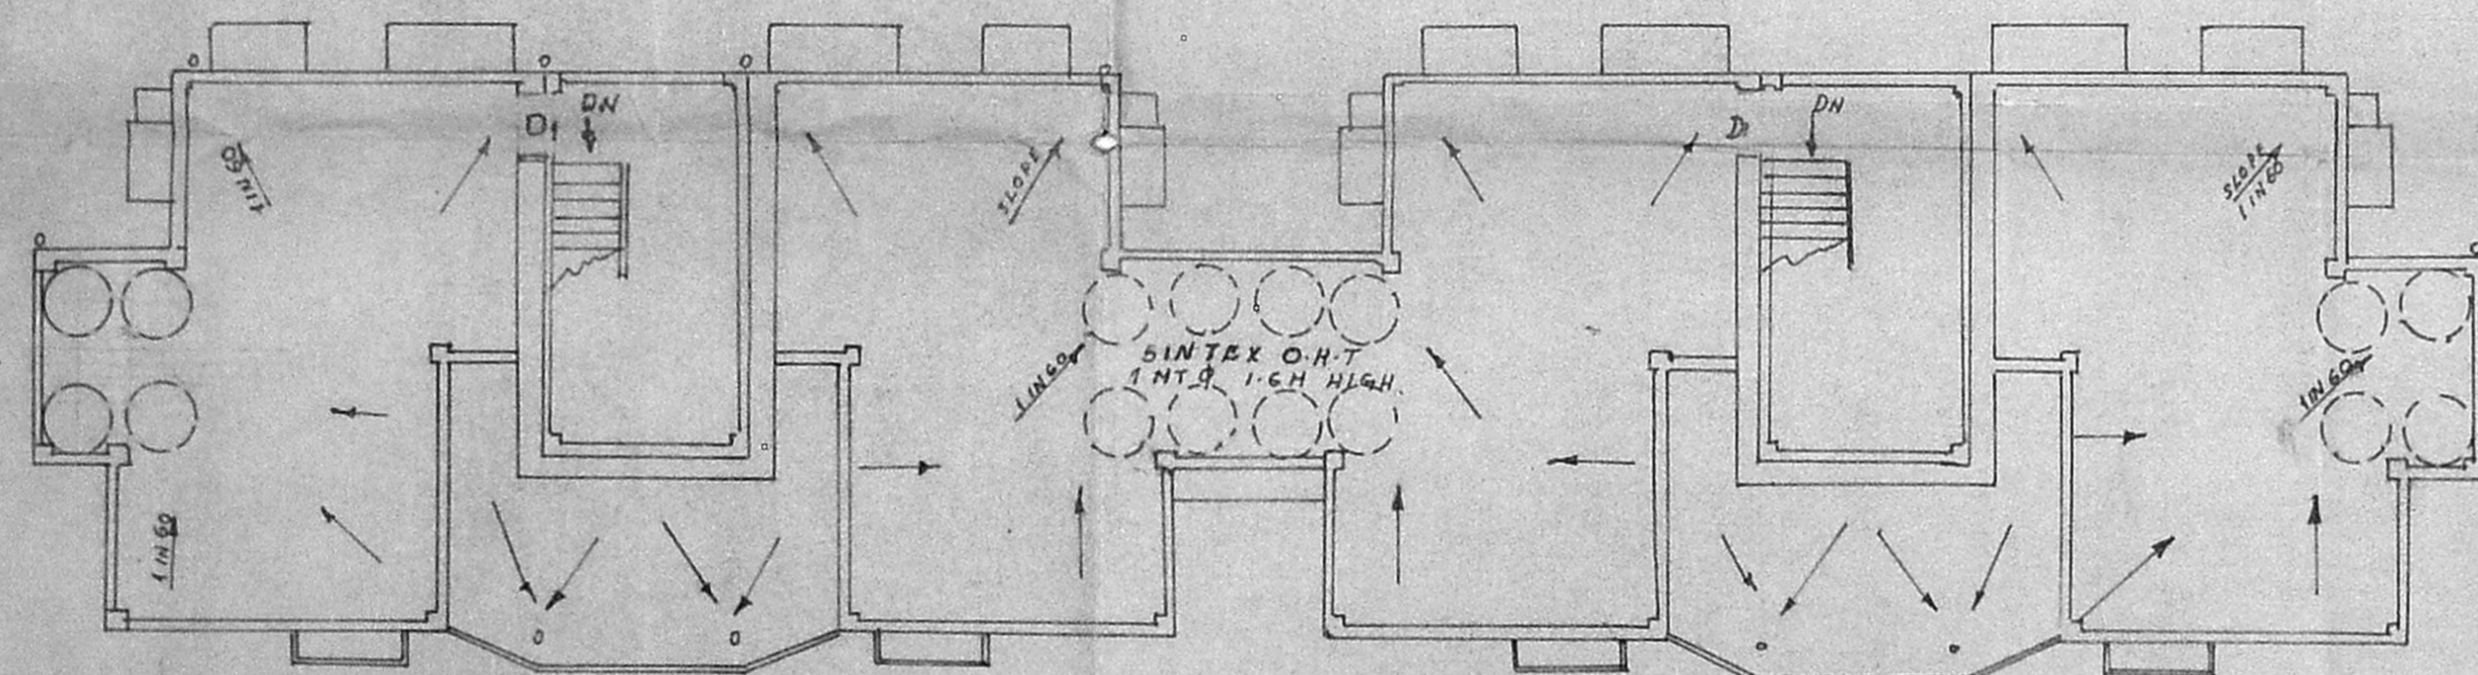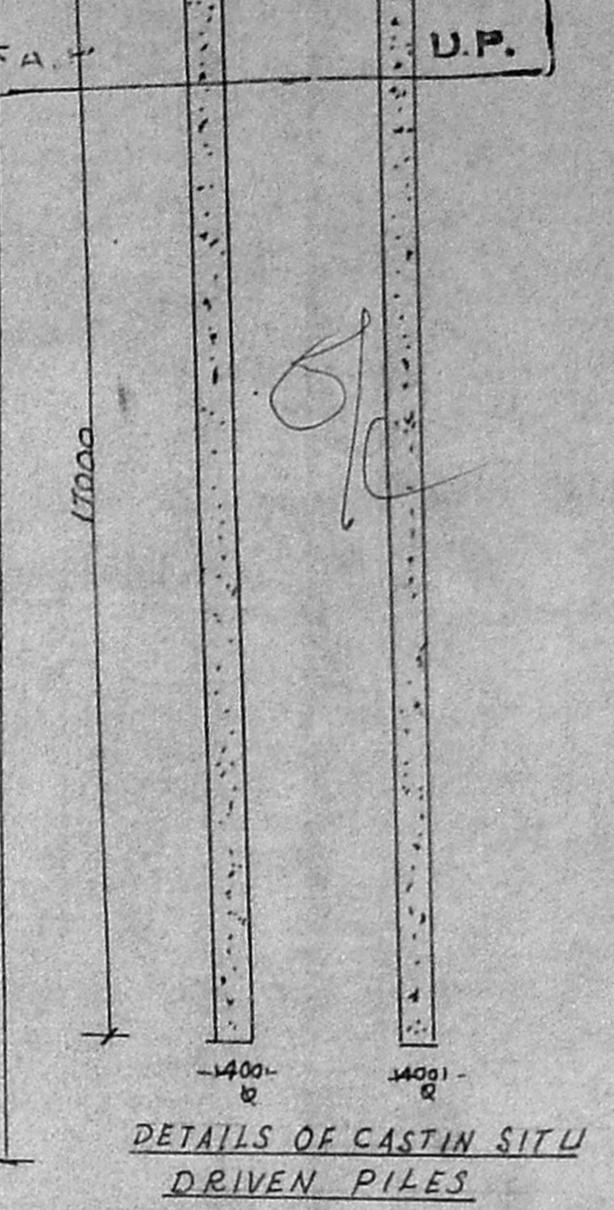


OPEN TERRACE PLAN

SCHEDULE OF DOORS & WINDOWS

D ₁	920 x 1980	C.W. DOOR, SINGLE LEAF FACTORY MADE FLUSH TYPE SHUTTER USING 25mm THK PARTICLE BOARD & STAMPED 15 3087/1985 TYPE-I WITH 'E' TYPE TERA WOOD BEADING BONDED WITH WATER RESISTANT ADHESIVE TO C.W. FRAME
D ₂	920 x 1980	C.W. DOOR SINGLE LEAF FACTORY MADE PANELLED SHUTTER USING 12mm THK PARTICLE BOARD AND STAMPED 15 3087/1985 TYPE-I WITH TOP RAILS VEHICLE STILES, LOCK RAILS, Etc. AS PER SPECIFICATION COVERED IN IS 1002/87 (PART I) WITH WATER RESISTING TREATMENT FIXED TO C.W. FRAME.
D ₃	820 x 1980	" " " " " " " "
W ₁	1850 x 1110	C.W. WINDOW WITH IRON BARS & FACTORY MADE C.W. SHUTER HALF PANELLED & HALF GLAZED
W ₂	800 x 1110	" " " " " " " "
W ₄	600 x 1110	" " " " " " " "
W ₅	600 x 430	C.W. WINDOW WITH GLAZED SHUTTER PROVIDED WITH IRON BARS.

PLINTH AREA :	
GROUND FLOOR	161 Sq. m
FIRST FLOOR	161 Sq. m
SECOND FLOOR	161 Sq. m
THIRD FLOOR	161 Sq. m
TOTAL	644 Sq. m

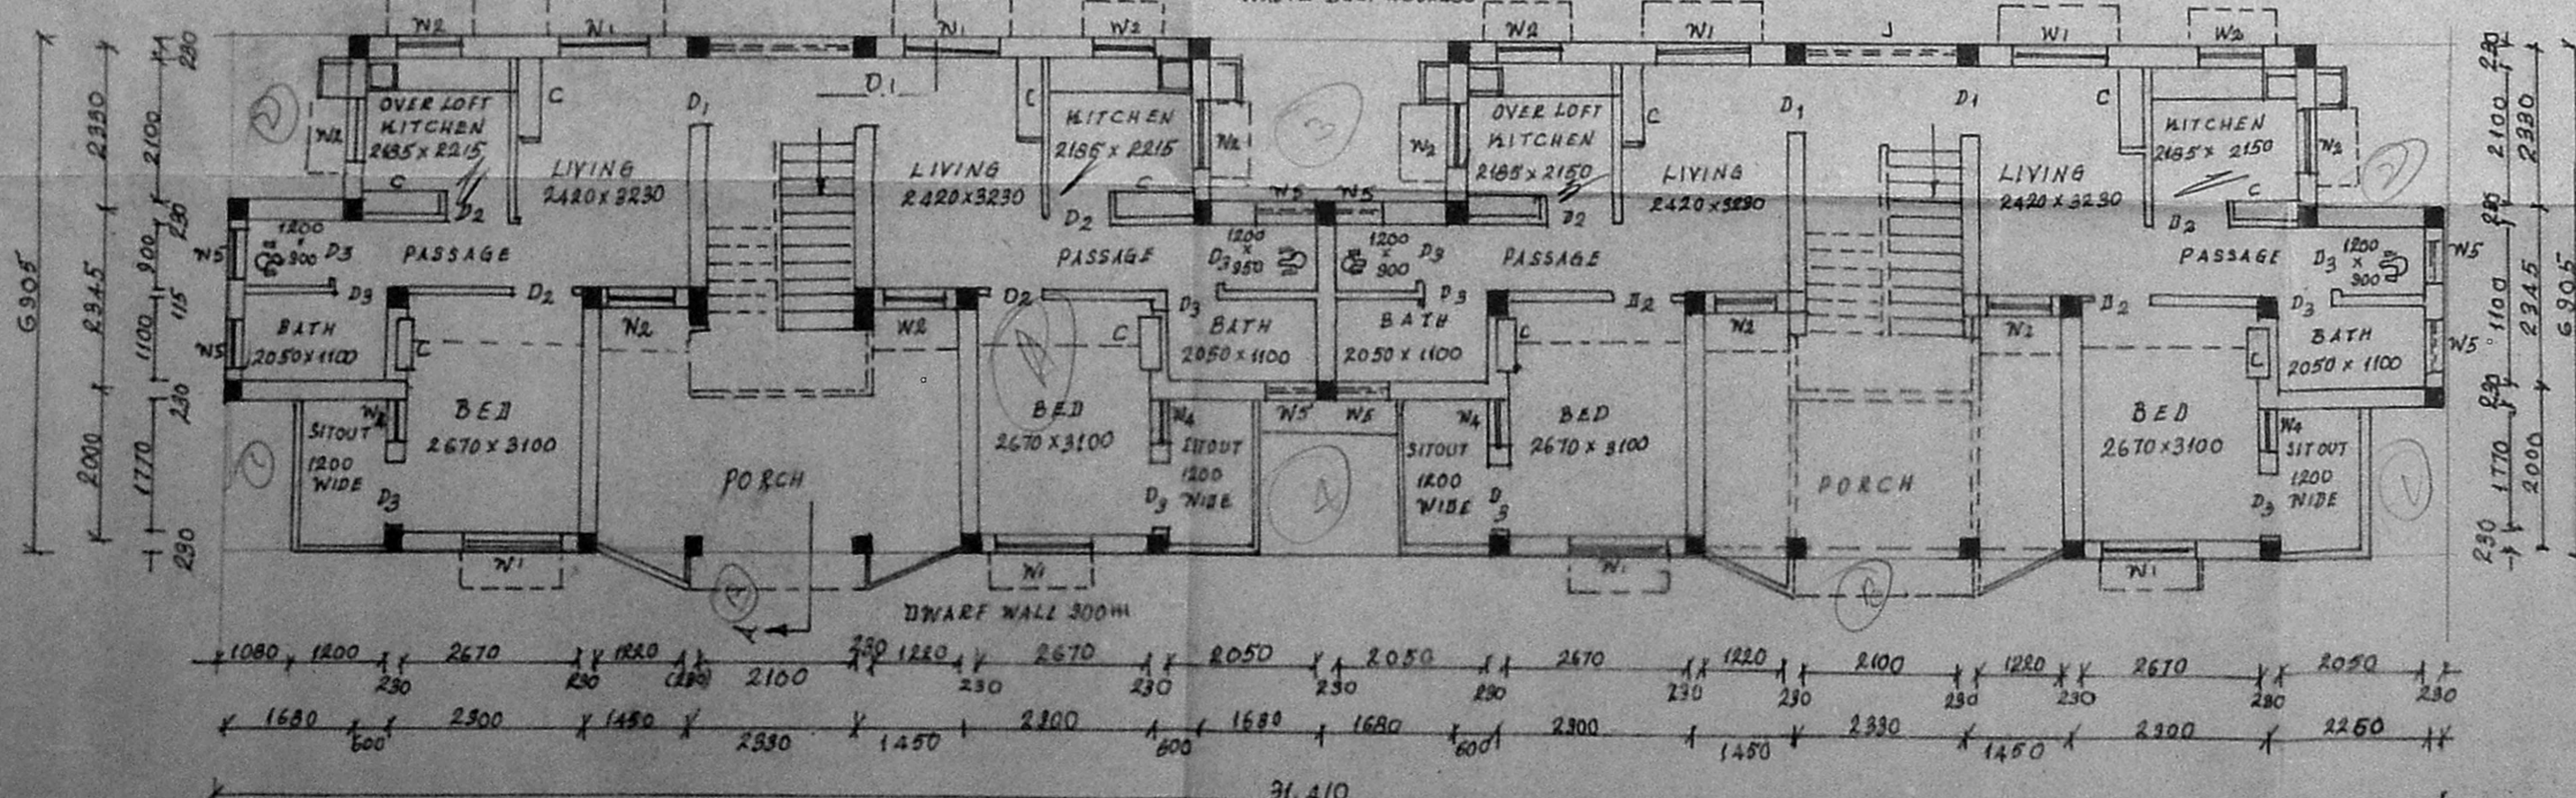

TYPICAL FLOORS PLAN
(G.ROUND, FIRST, SECOND & THIRD)

Superintending Engineer (Civil-II),
NORTH MADRAS THERMAL POWER PROJECT
ENORE, MADRAS-57.

OWNERS SIGNATURE

S. Subramaniam,
ARCHITECT AND INTERIOR DESIGNER
LICENCED CLASS-I, SURV. NO. 90
8/1, VIDYARANYA, 11th MAIN ROAD,
KASTURIBAI NAGAR, ADYAR
MADRAS-600 020. TEL: 411305.

LICENSED SURVEYOR

DRAWN	TAMIL NADU ELECTRICITY BOARD NORTH MADRAS THERMAL POWER PROJECT	DRG NO.
CHECKED		
PASSED	TYPE 'P' QUARTERS	DATE
TRACED	PLAN, ELEVATION & SECTION	SCALE 1:100


DIMENSIONS ARE GIVEN IN M.M.

Pre 20


B/16521/188 C/H/93 dt. 10/5/63

Planning Permt No.
APPROVED
SUBJECT TO THE CONDITIONS IN THIS OFFICE LETTER.
BY No. 21099/72 Date. 10/5/63


SECRETARY
MUNICIPALITY
MADRAS
CITY CORPORATION

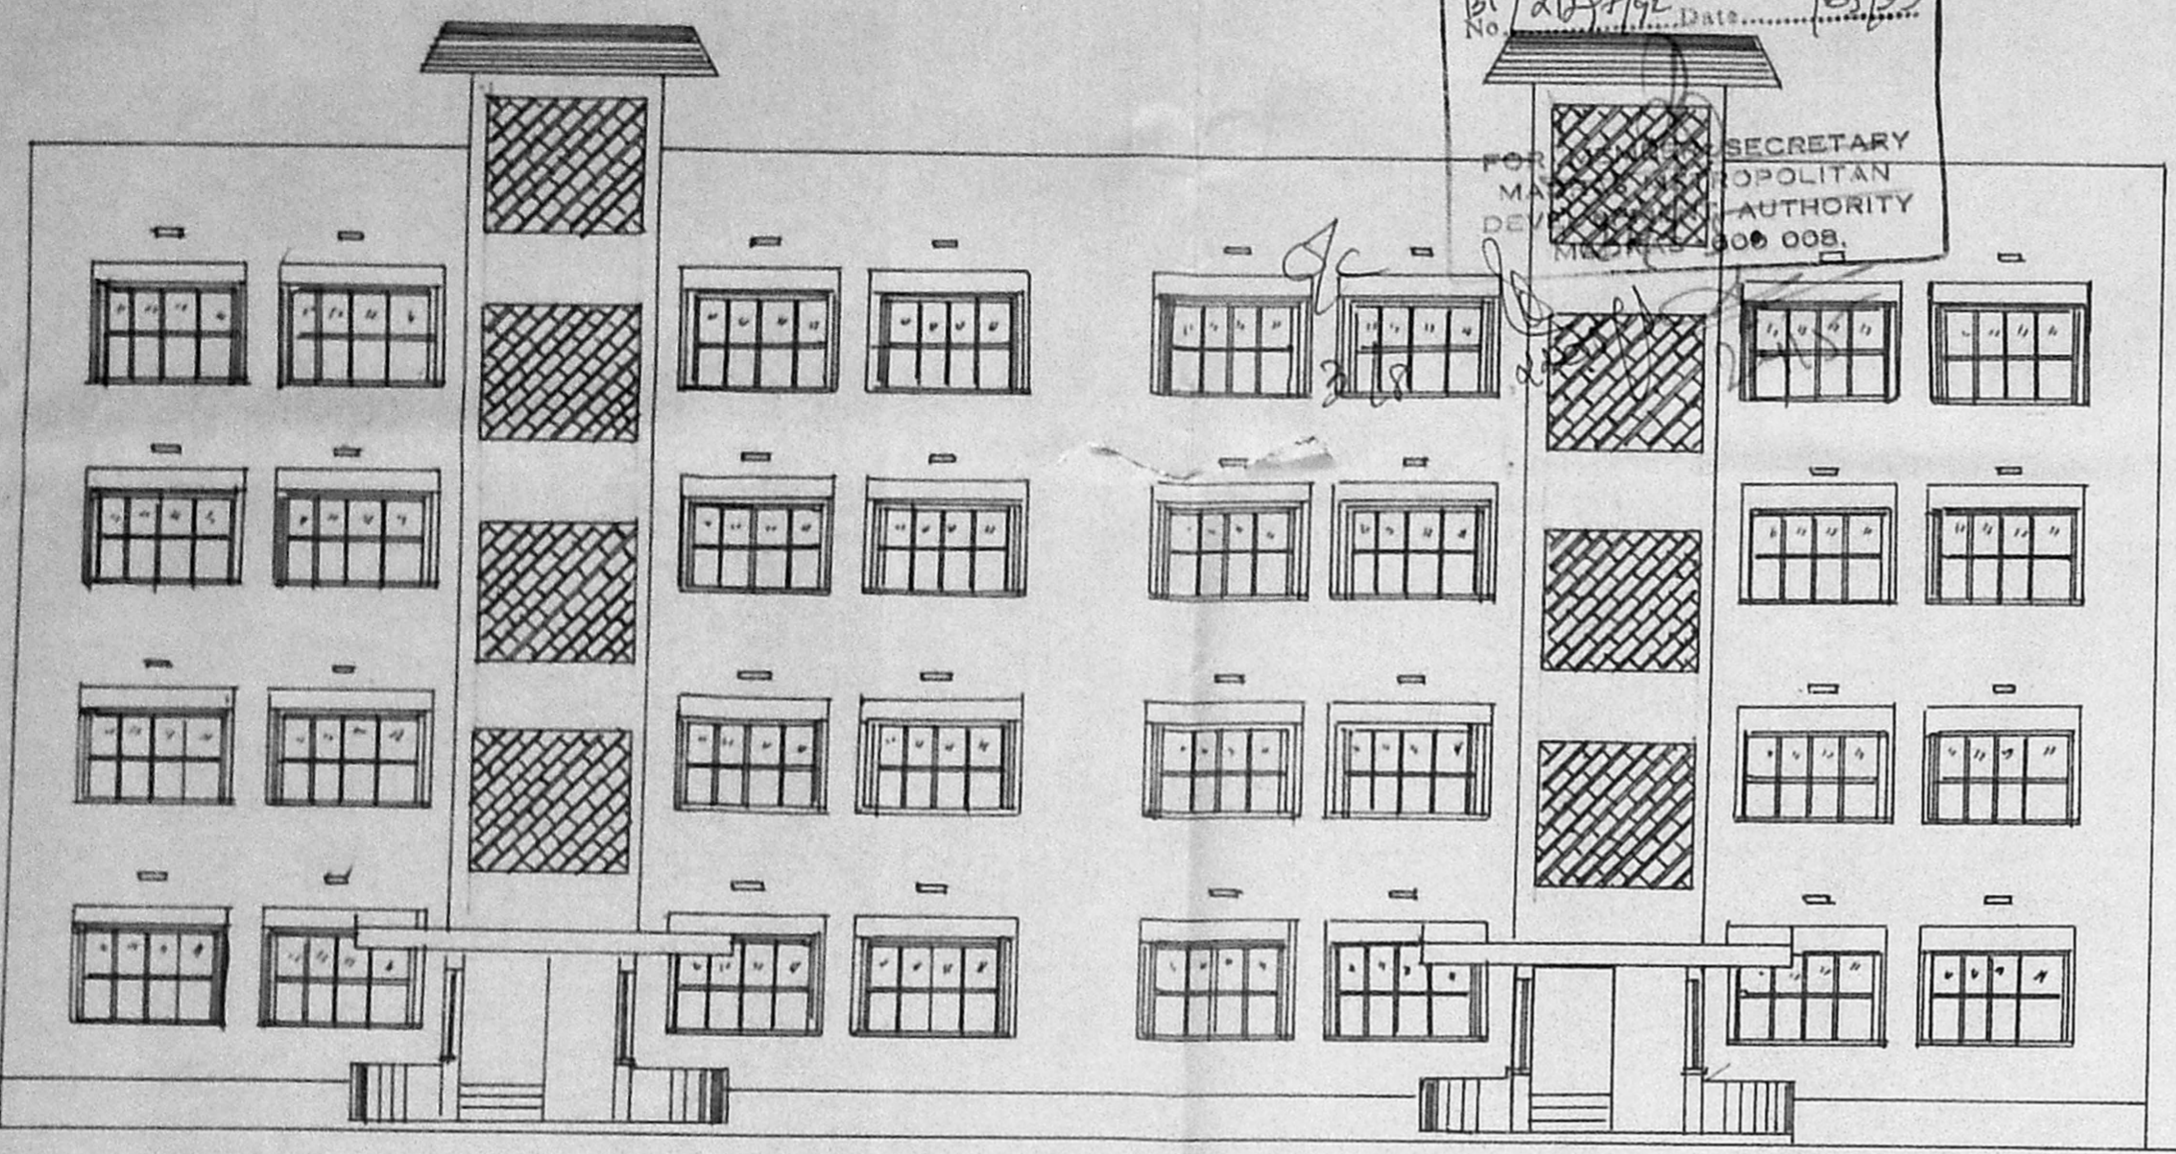


ELEVATION

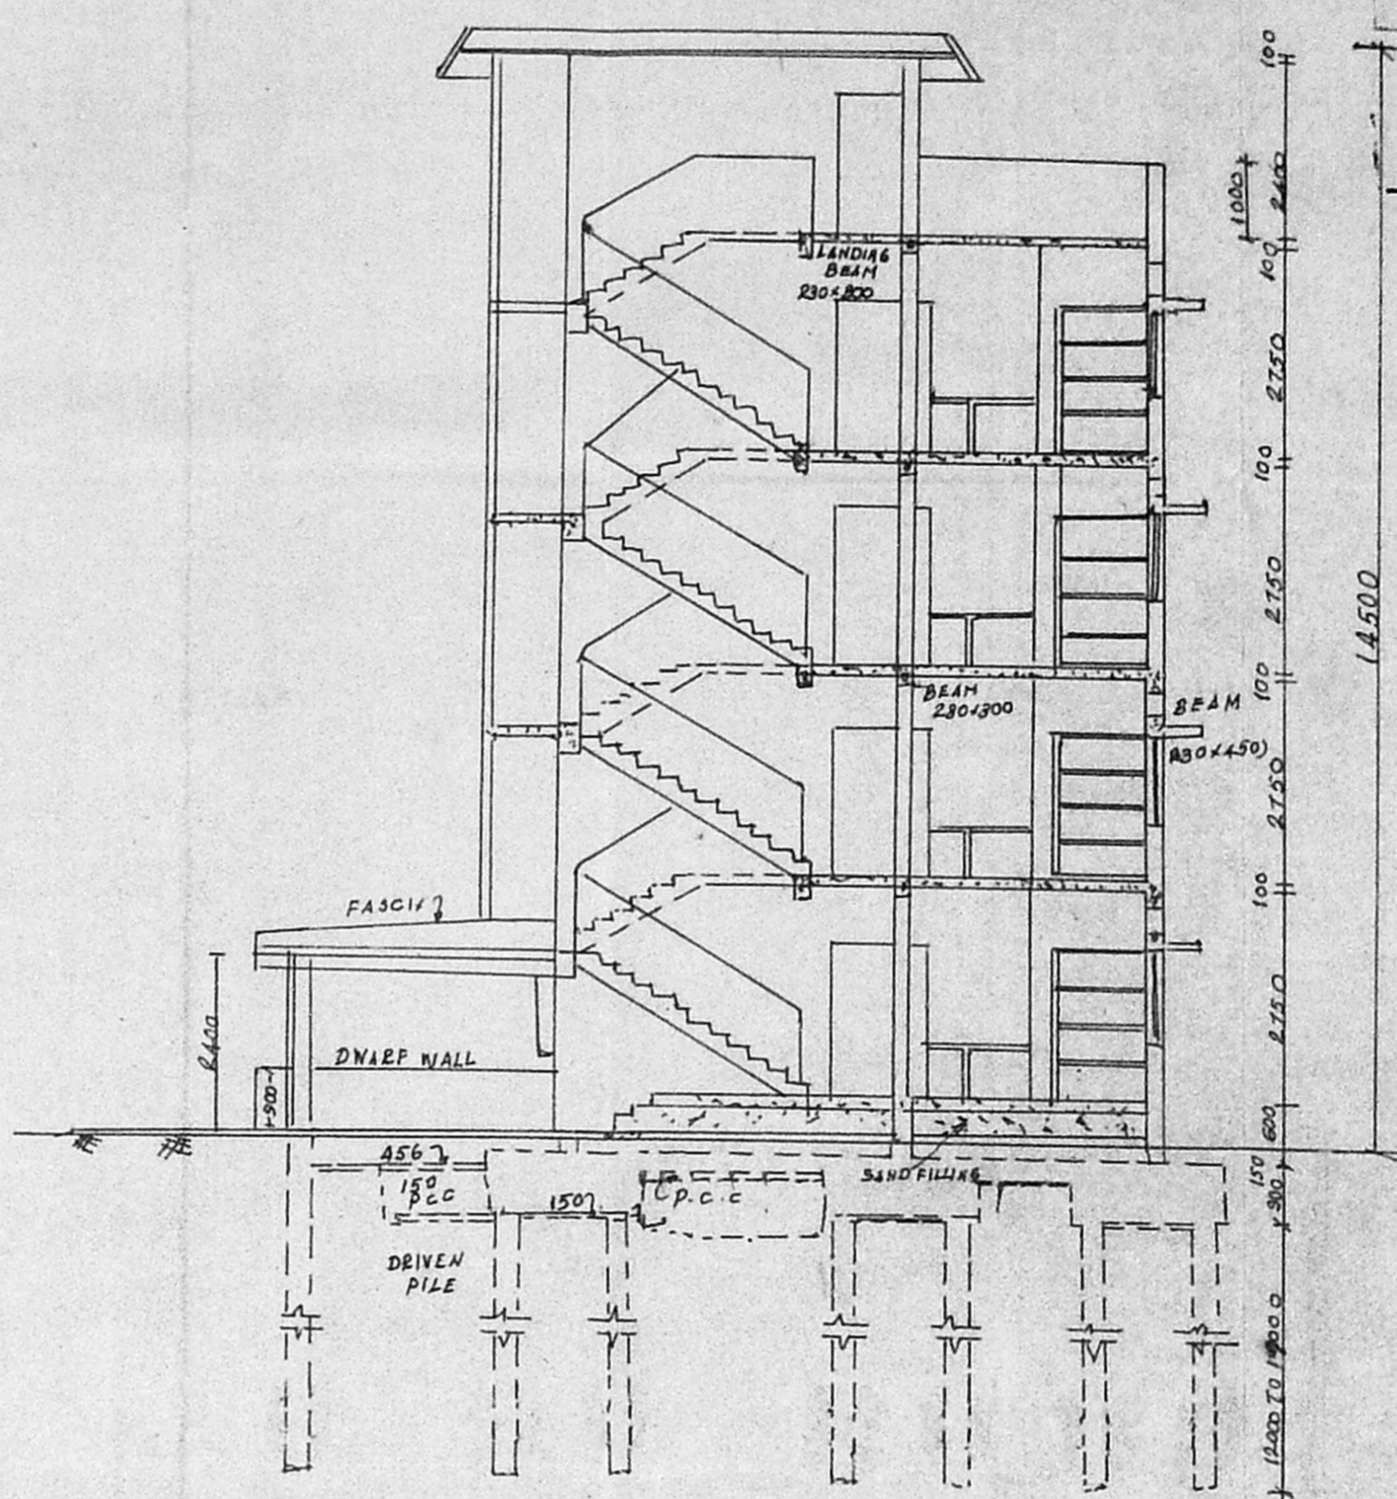

SECTION 1-1

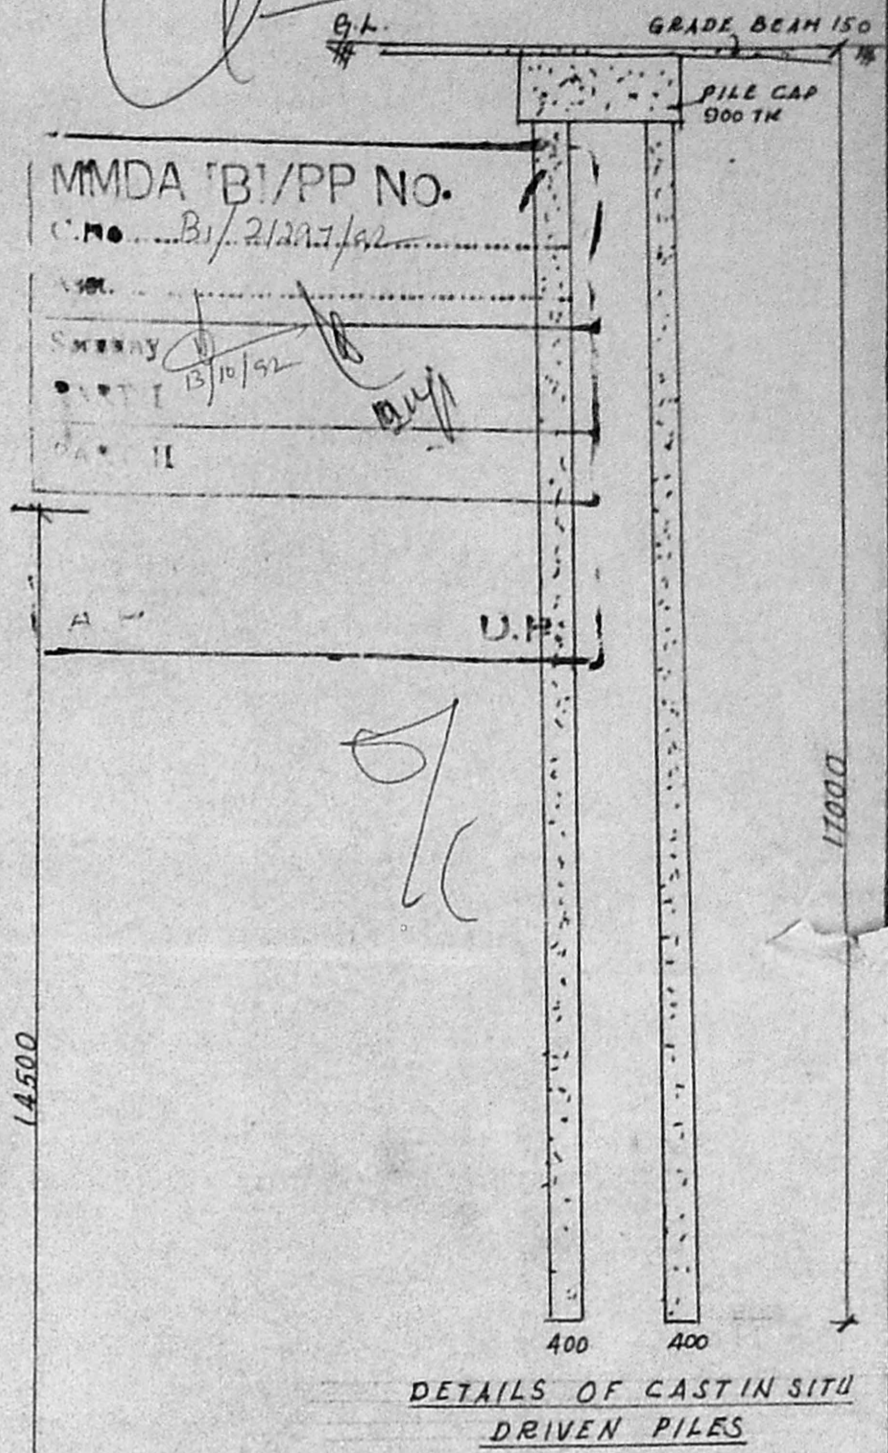


DETAILS OF CAST IN SITU DRIVEN PILES

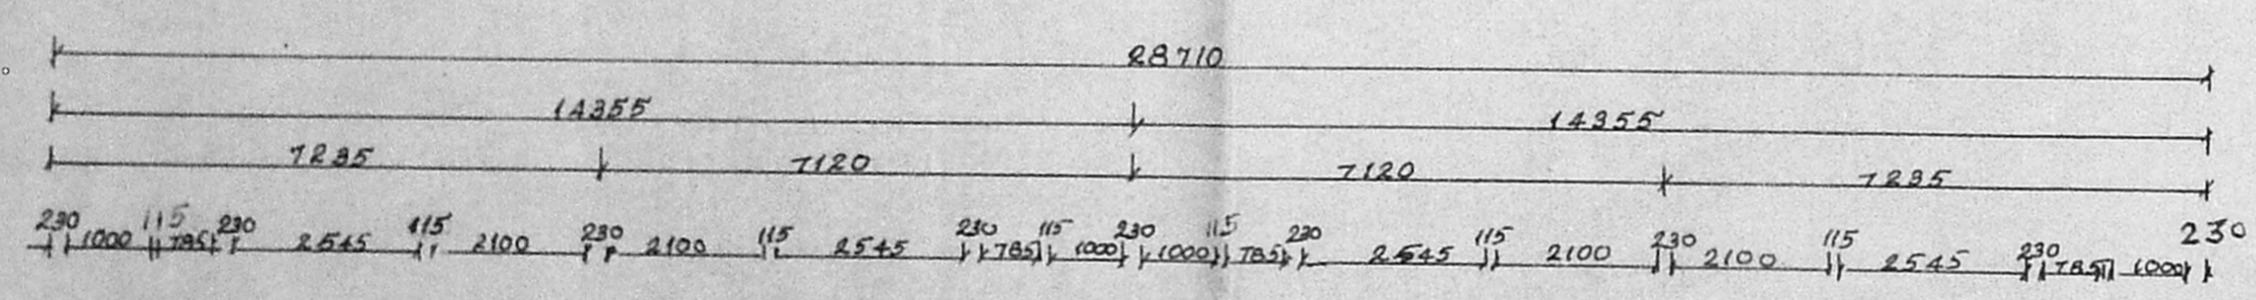

SCHEDULE OF DOORS & WINDOWS	
D1	920x1980 C.W. DOOR, SINGLE LEAF FACTORY MADE FLUSH SHUTTER USING 25 MM PARTICLE BOARD AND STAMPED IS 8087/1985 TYPE I WITH 'E' TYPE T.N. BEADING BONDED WITH WATER RESISTANT ADHESIVE FIXED TO C.W. FRAME
D2	920x1980 C.W. DOOR SINGLE LEAF FACTORY MADE PANALLED SHUTTERS USING 12 MM PARTICLE BOARD & STAMPED IS 3087/1985 TYPE I WITH TOP RAILS VERTICAL STYLES, LOCK RAILS ETC., AS PER SPECIFICATION COVERED IN IS 1003/1977 (PART) WITH WATER RESISTING TREATMENT FIXED TO C.W. FRAME
D3	820 x 1980
D4	750 x 1980
W1	1250 x 1110 C.W. WINDOW WITH IRON BARS FACTORY MADE COUNTRY WOOD SHUTTERS HALF PANELLLED & HALF GLAZED
W2	900 x 1110
W4	600 x 1110
W5	600 x 450 C.W. WINDOW WITH GLAZED SHUTTERS PROVIDED WITH IRON BARS


EACH ENTRANCE DOOR IS TO BE PROVIDED WITH A DOOR CHAIN

COLLINTH AREA:	
GROUND FLOOR	: 210 Sq. M
FIRST FLOOR	: 210 "
SECOND FLOOR	: 210 "
THIRD FLOOR	: 210 "
TOTAL	: 840 "

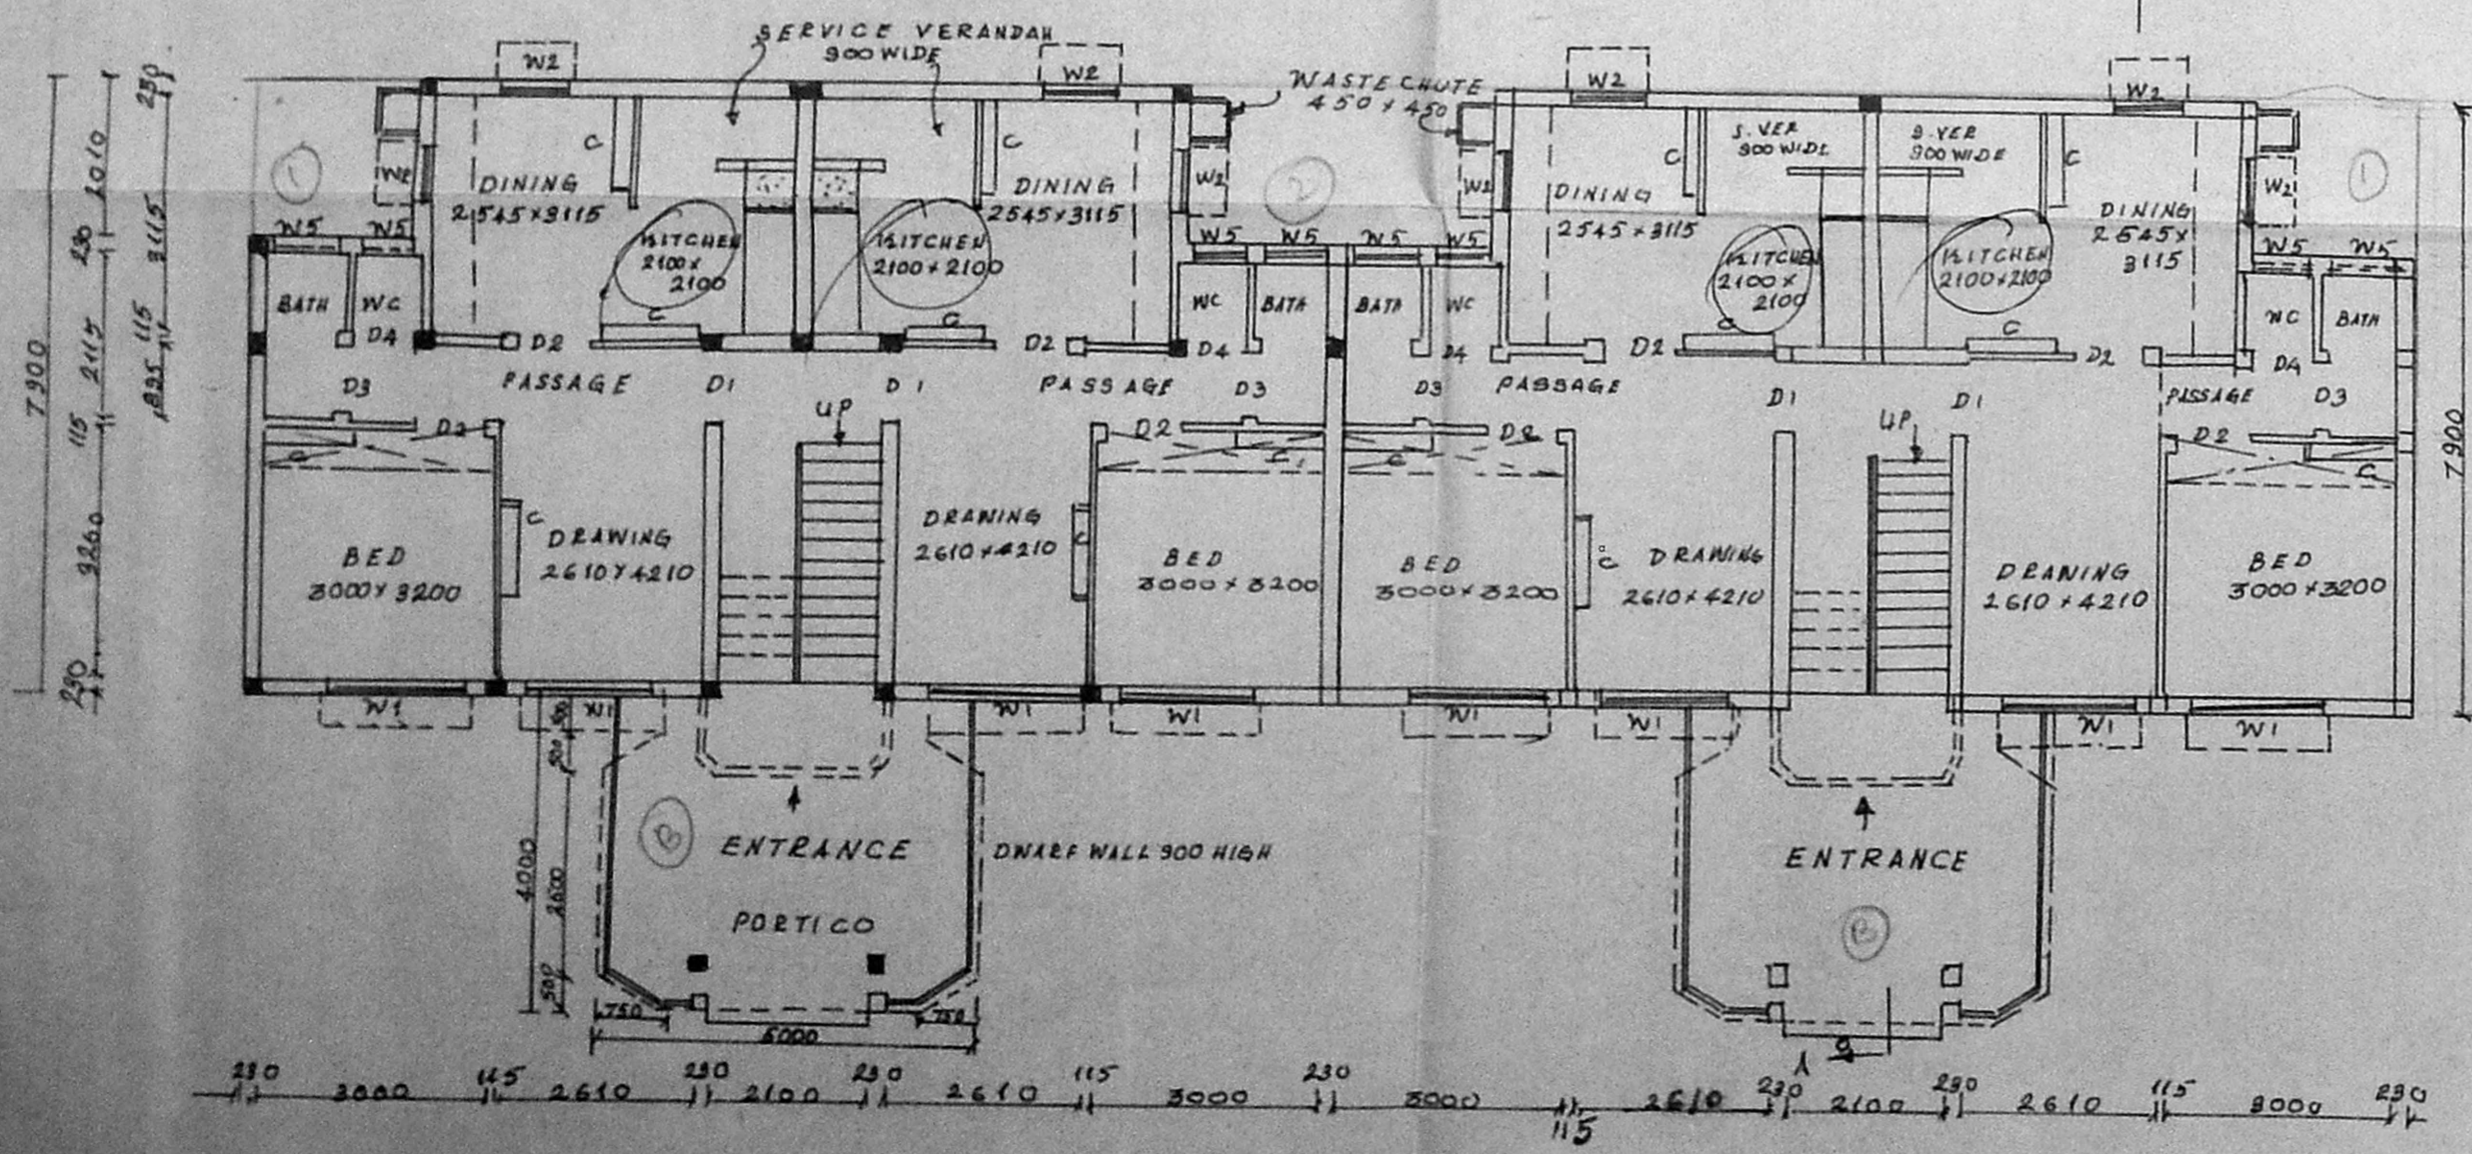

PLAN

(GROUND FLOOR, FIRST FLOOR, SECOND FLOOR, THIRD FLOOR)

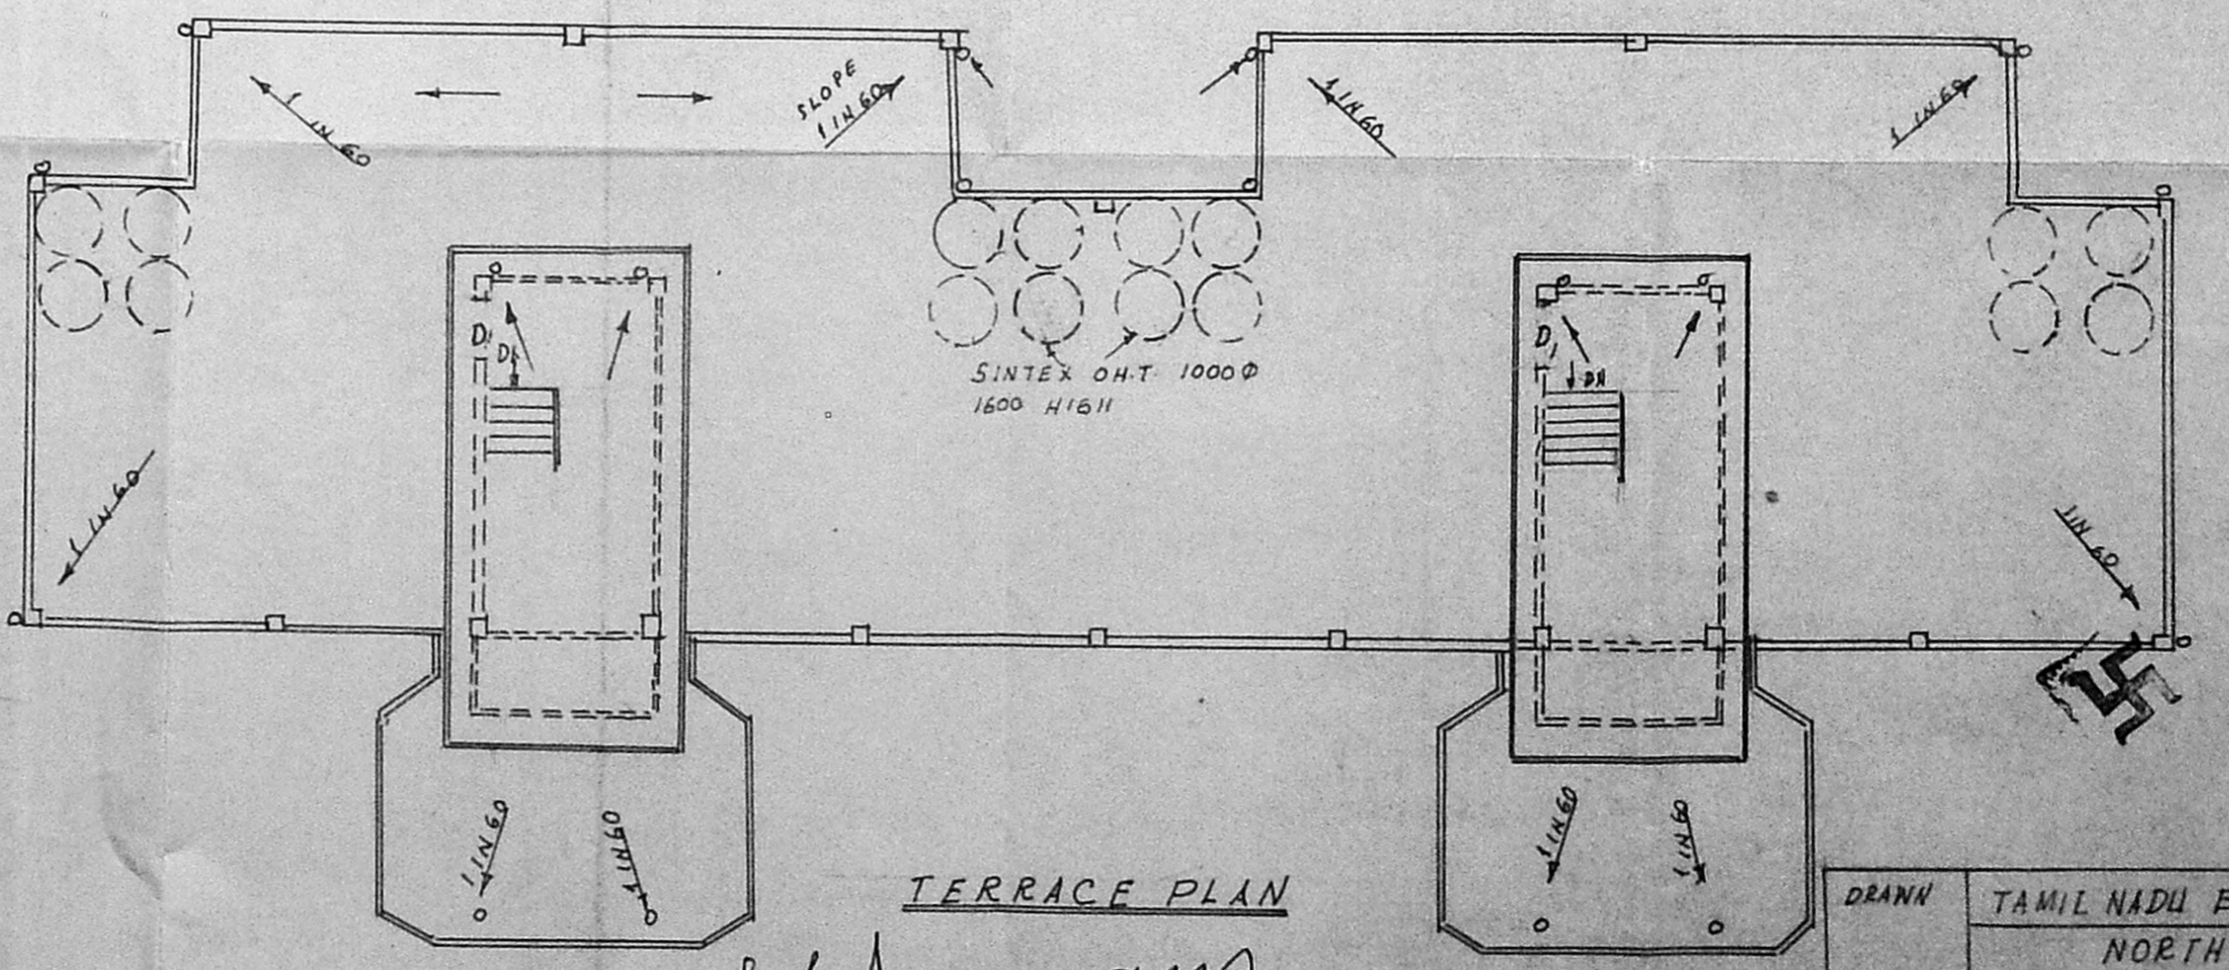

TERRACE PLAN

Superintending Engineer/Civil-II
NORTH MADRAS THERMAL POWER PROJECT
ENMORE MADRAS-57.
OWNER

S. S. SURESHAN
ARCHITECT AND INTERIOR DESIGNER
LICENCED CLASS-I, SURVEYOR NO: 90
8/1, VIDYARANYA, II AD MAIN ROAD,
KASTURBA NAGAR, ADYAR
MADRAS-600 020. TEL: 411305




DRAWN	TAMIL NADU ELECTRICITY BOARD	DRG NO
CHECKED	NORTH MADRAS	DATE
PASSED	THERMAL POWER PROJECT	SCALE
	TYPE @ QUARTERS	1:100

ALL DIMENSION ARE IN M.M.

B/16521/188 D/H/D3 dt. 10/5/53

Planning Permit No.
APPROVED
 SUBJECT TO THE CONDITIONS IN
 THIS OFFICE LETTER.
 B/16521/188 D/H/D3 dt. 10/5/53


FOR MEMBER SECRETARY
 MADRAS METROPOLITAN
 DEVELOPMENT AUTHORITY
 MADRAS - 600 008.

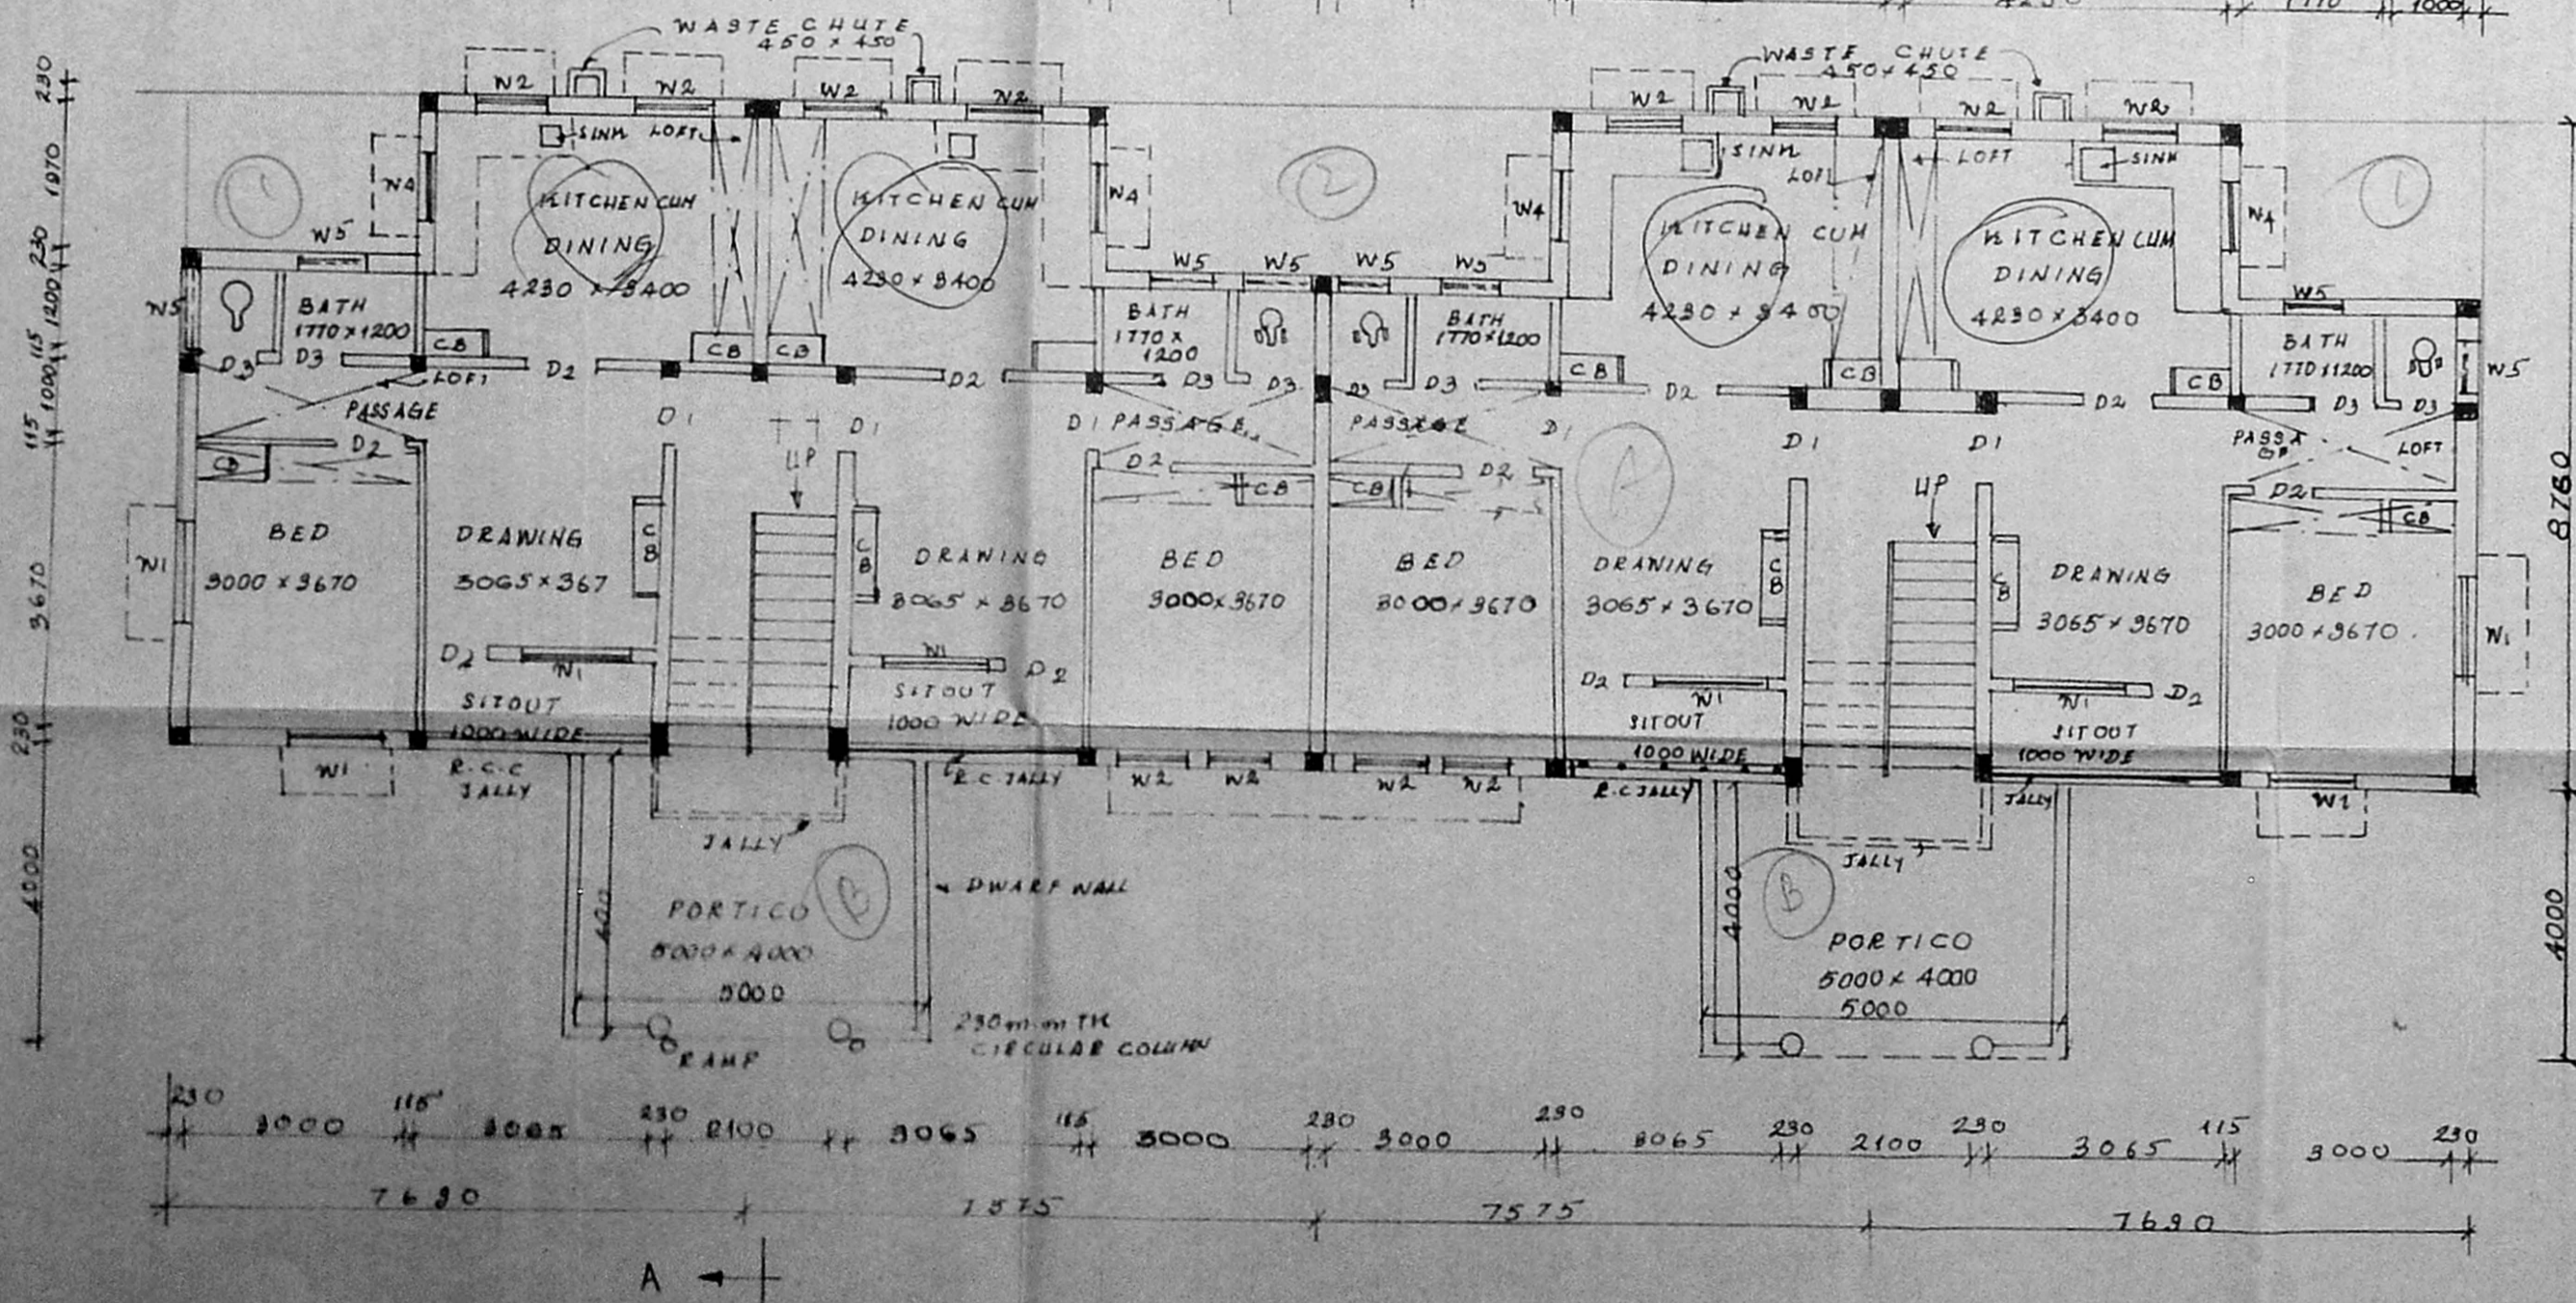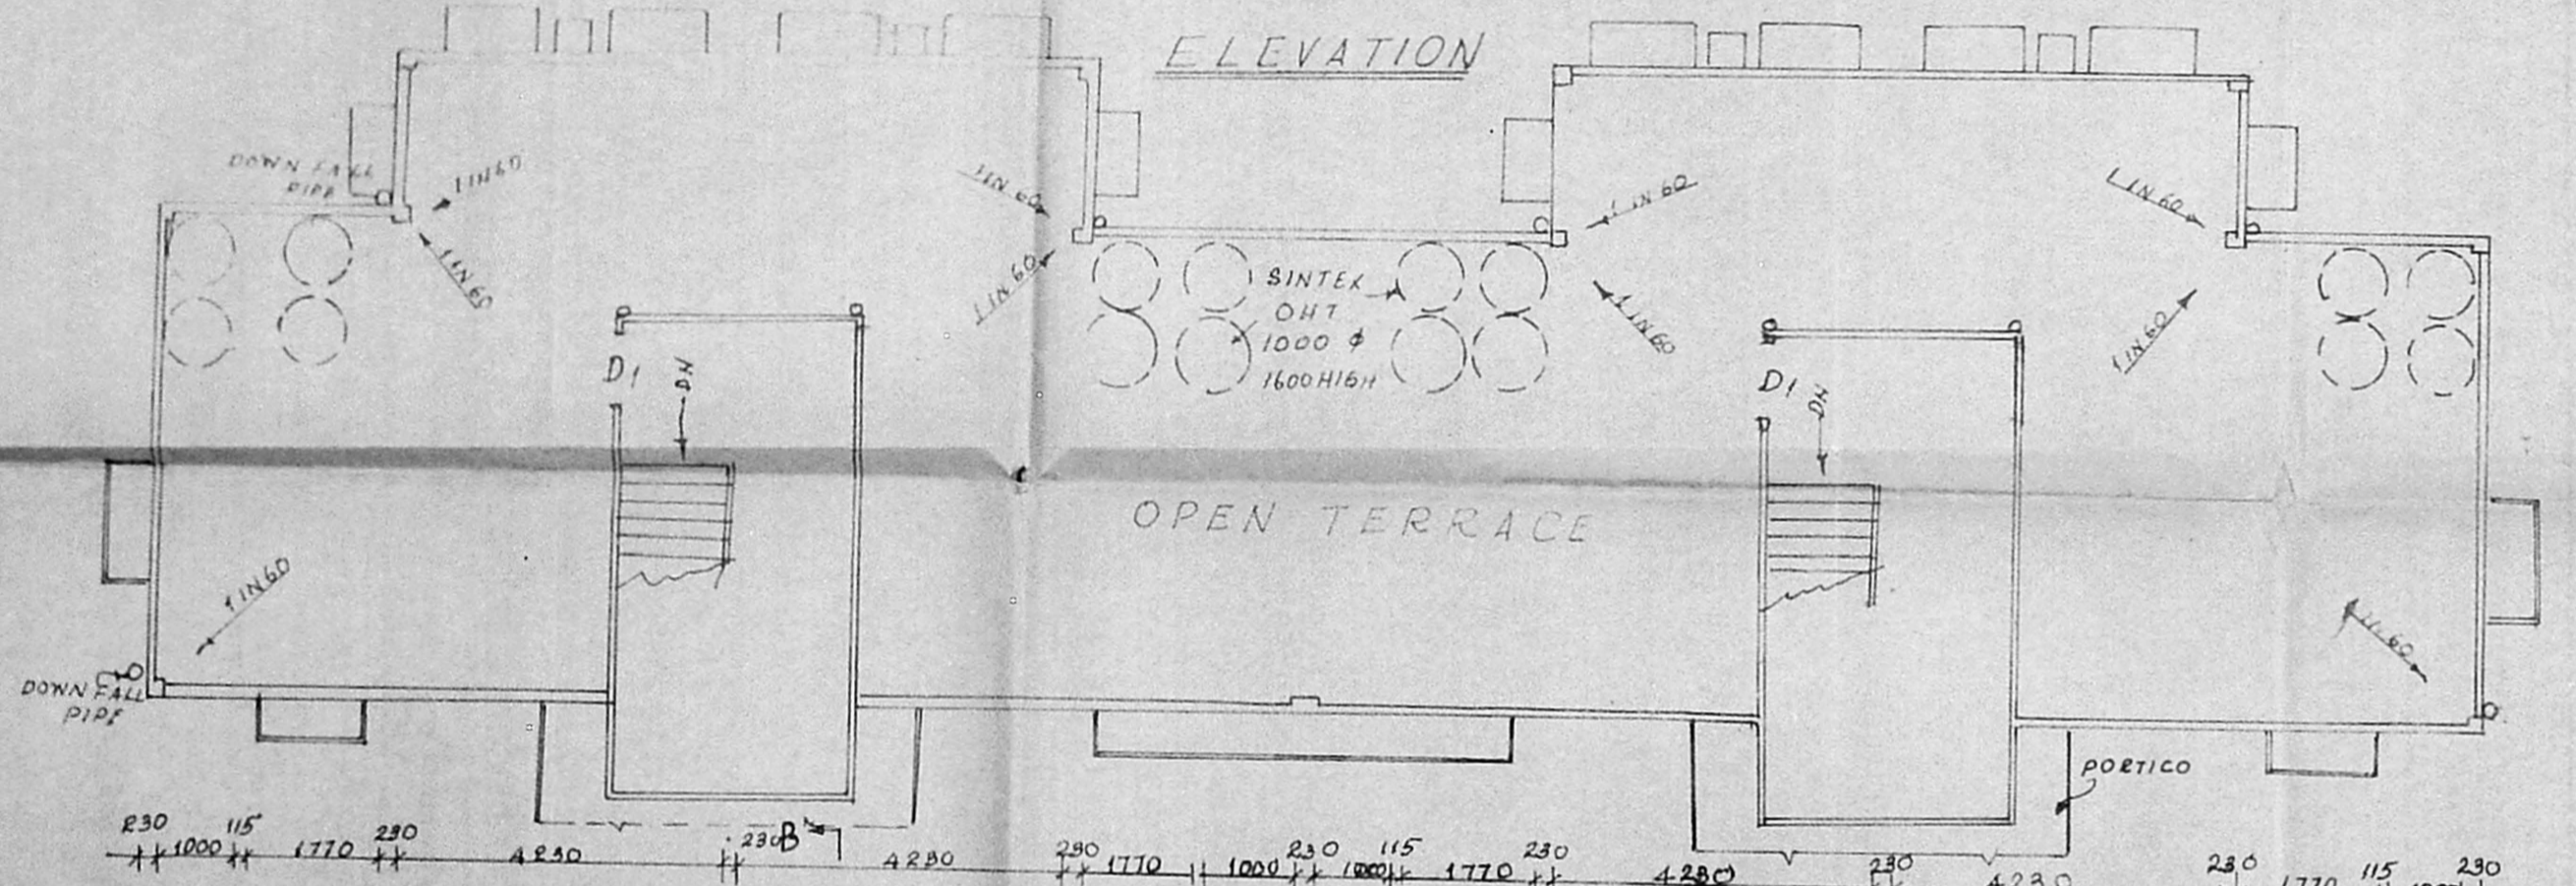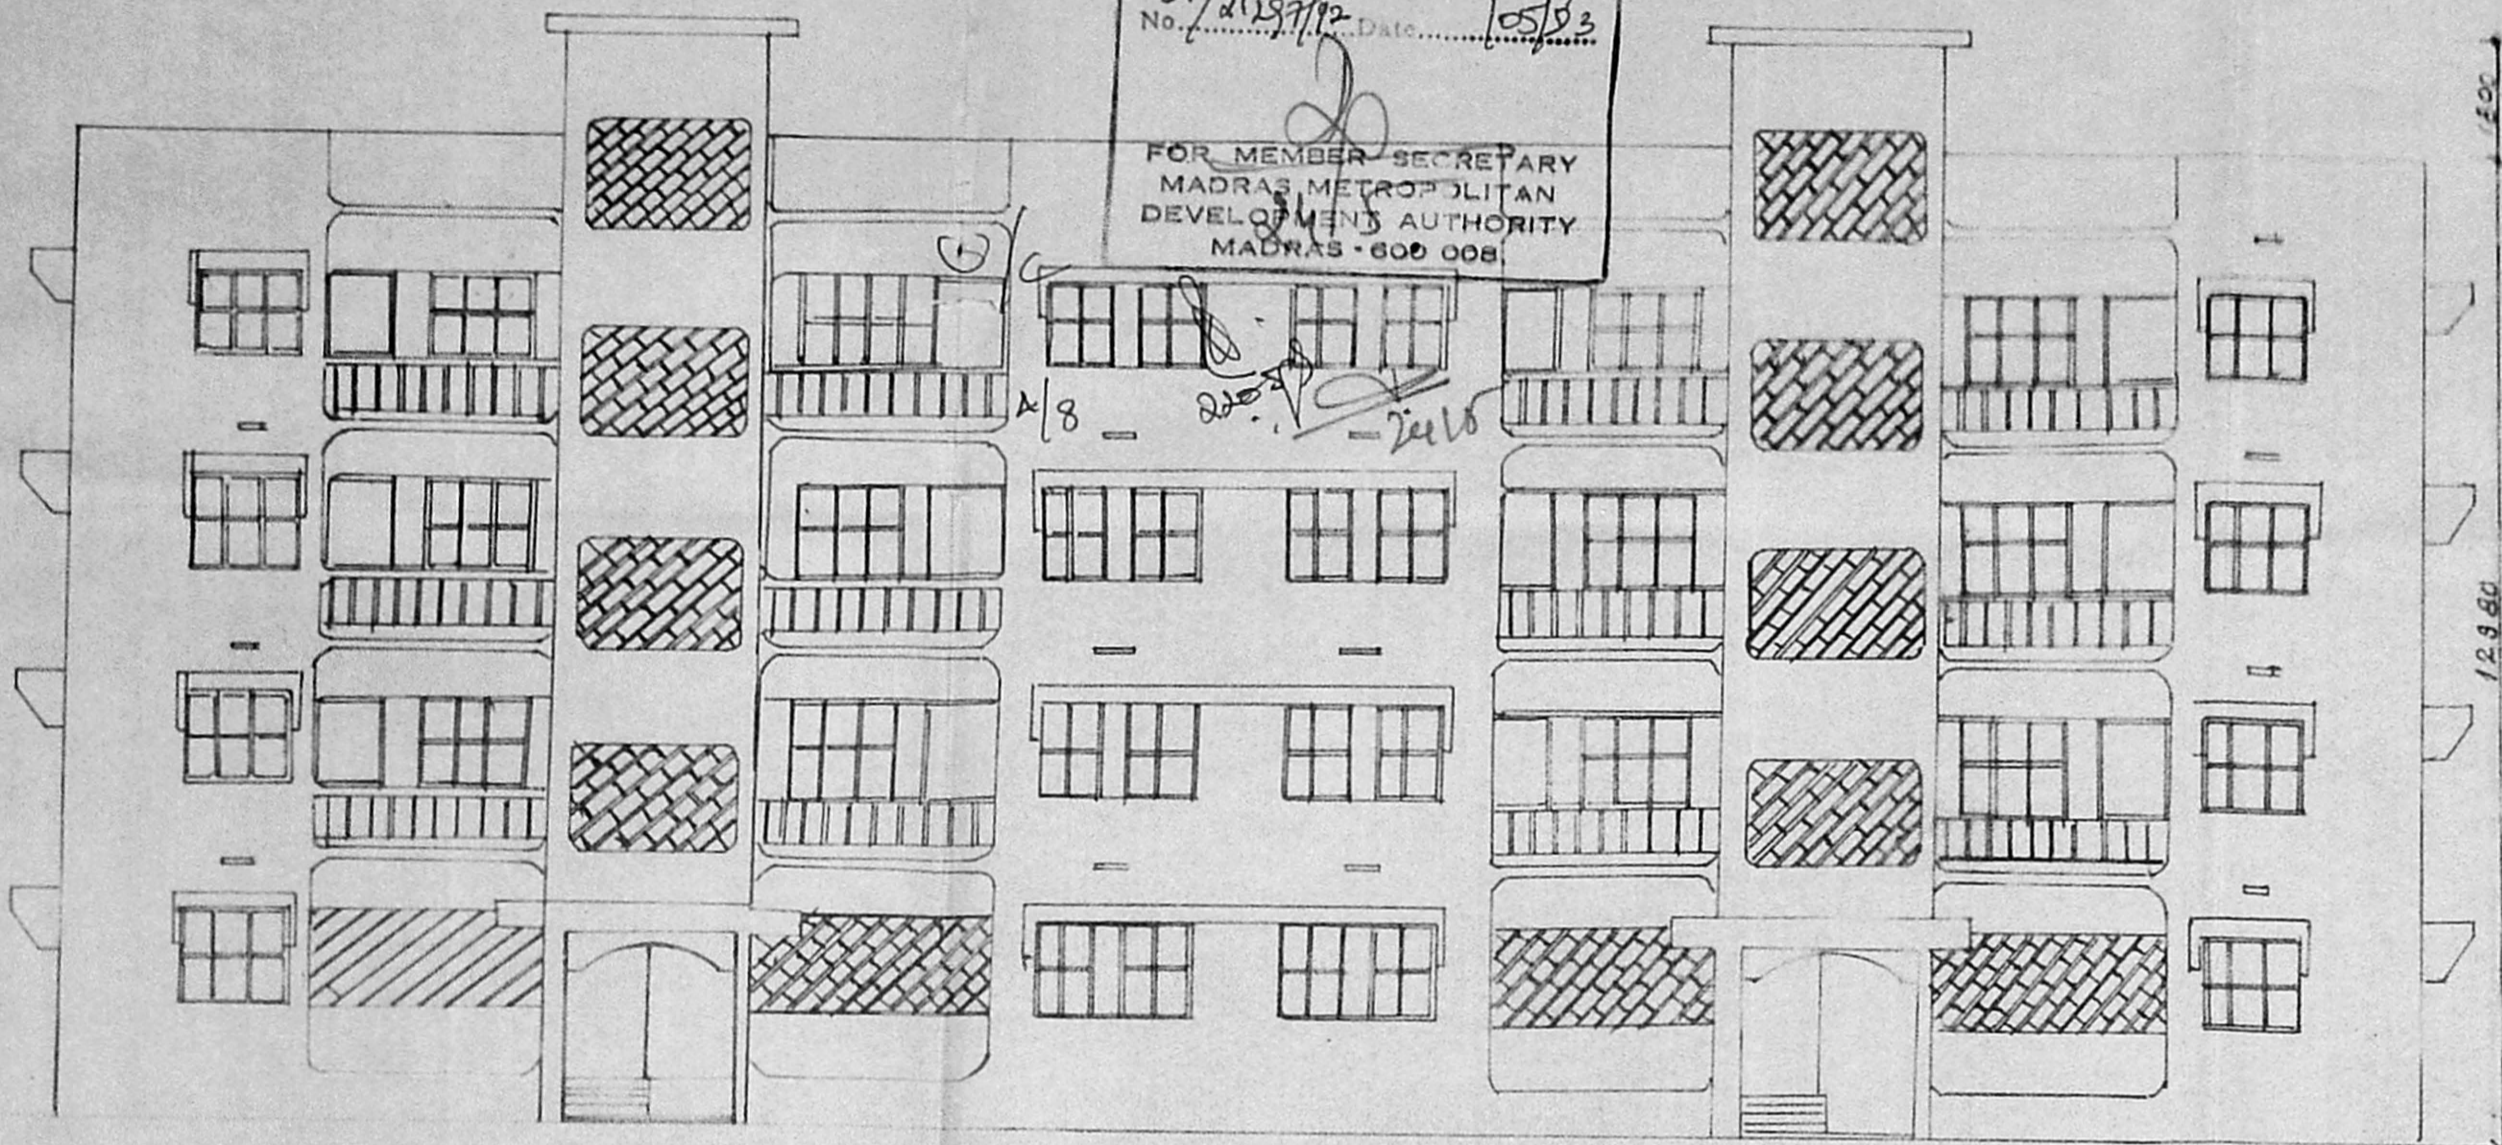

PLAN OF GROUND & TYPICAL FLOORS
 (G.F., F.F., S.F. & T.F.)

DIMENSIONS GIVEN ARE IN M.M.

MMDA (B)/PP NO. 1
 C.No. B/16521/188
 PART I
 PART II

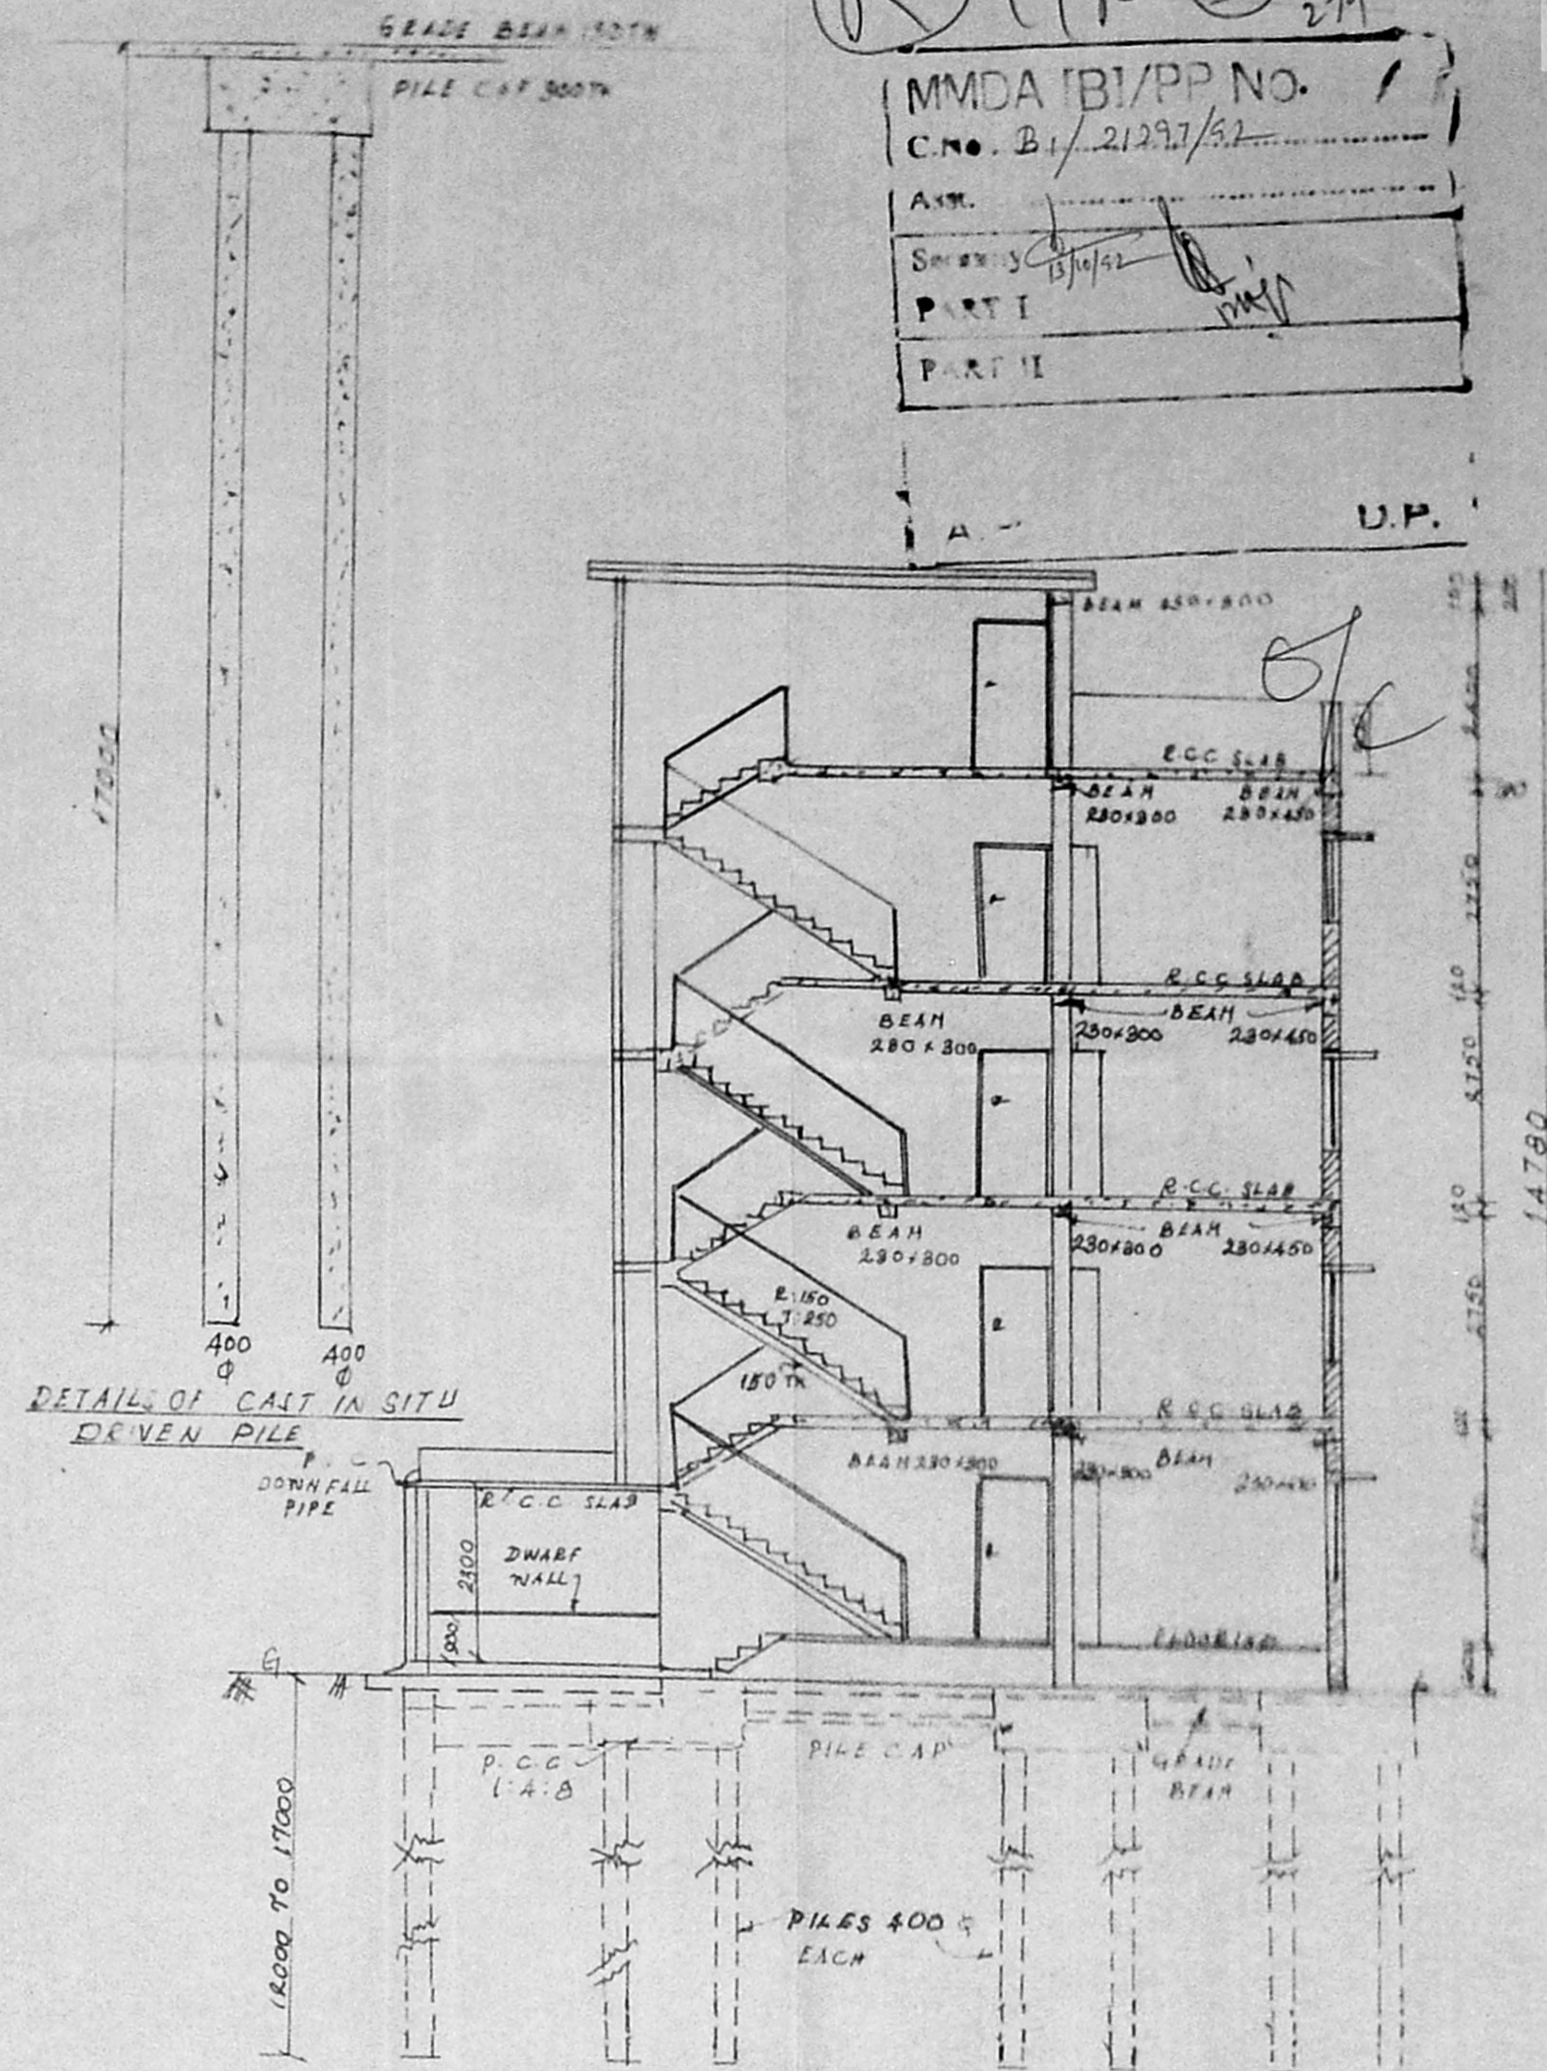

SECTION ON A-B

SCHEDULE OF DOORS & WINDOWS

D DOOR 820x1880 C.W. DOOR, SINGLE LEAF FACTORY MADE FLUSH TYPE SHUTTER USING 25 MM PARTICLE BOARD & STAMPED IS 808T/1985 TYPE I WITH E' TYPE T.W. BEADING WITH WATER RESISTANT ADHESIVE, FIXED TO C.W. FRAME

D₂ DOOR 920x1980 C.W. DOOR SINGLE LEAF FACTORY MADE PANELED SHUTTERS USING 12 MM PARTICLE BOARD & STAMPED IS 808T/1985 TYPE I WITH TOP RAILS, VERTICAL STILES, LOCK RAIL ETC. AS PER SPECIFICATION COVERED IN IS 1002 - 1977 (PART I) WITH WATER RESISTANT TREATMENT, FIXED TO C.W. FRAME

D₃ DOOR 820x1980 - do.

N WINDOW 1850x1110 C.W. WINDOW WITH IRON BARS & FACTORY MADE SHUTTERS HALF PANELED & HALF GLAZED

N₂ " 900x1110 "

N₄ " 600x1110 "

N₅ " 600x450 C.W. WINDOW WITH GLAZED SHUTTERS PROVIDED WITH IRON BARS

PLINTH AREA :

GROUND FLOOR	363.59 m ²
FIRST FLOOR	363 "
SECOND FLOOR	363 "
THIRD FLOOR	363 "
TOTAL	1152 "

Superintending Engineer (Civil-II)
 NORTH MADRAS THERMAL POWER PROJECT
 ENNORE, MADRAS-57.

S. Subramaniam M. Arch. A.I.T.A.,
 ARCHITECT AND INTERIOR DESIGNER,
 LICENCED CLASS-I, SURVEYOR NO: 90
 8/1, VIDYARANYA, 11th MAIN ROAD,
 KASTURIBAI NAGAR, ADYAR
 MADRAS-600 020. TEL: 411305

OWNER	TAMIL NADU ELECTRICITY BOARD	DBE-10
DRAWN		
CHECKED	NORTH MADRAS THERMAL POWER PROJECT	
PASSED		DATE
TRACED	TYPE 'R' QUARTERS	SCALE 1:100

D/16521/188 E/H/23 dt. 10/5/83


Planning Permit No.

APPROVED

SUBJECT TO THE CONDITIONS IN THIS OFFICE LETTER.

No. B1/21297/92 Date 10/5/83

FOR MEMBER SECRETARY
MADRAS METROPOLITAN
DEVELOPMENT AUTHORITY
MADRAS - 600 008.

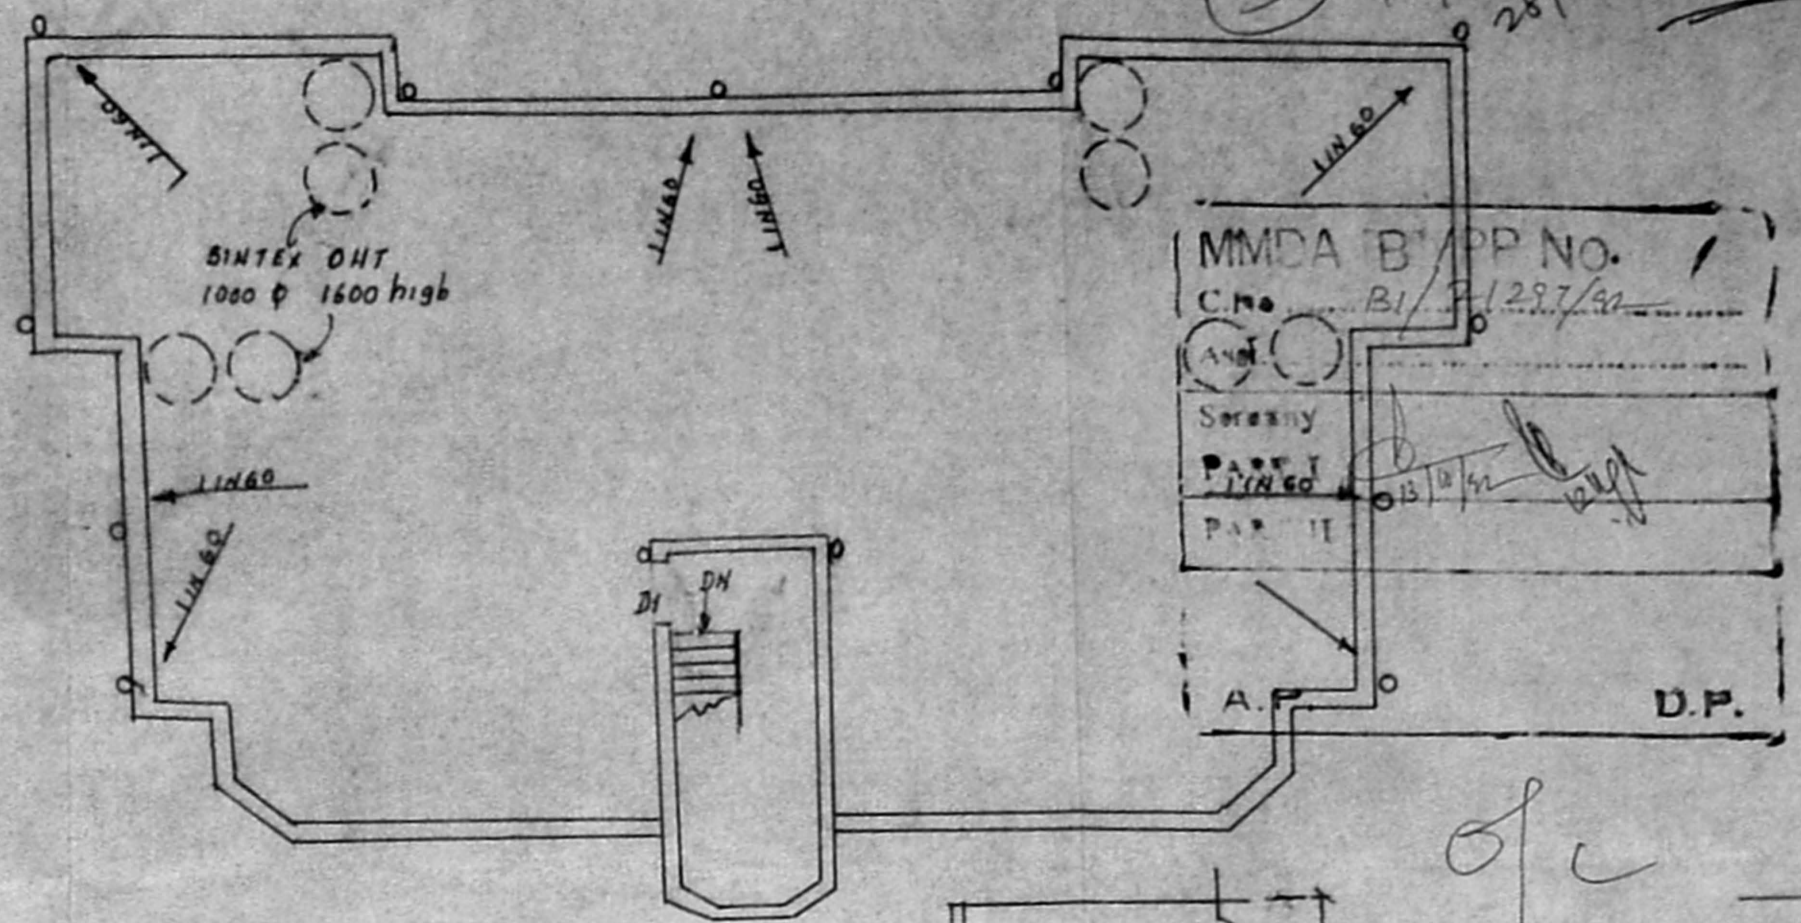

TERRACE PLAN


SCHEDULE OF DOORS & WINDOWS.

D	DOOR	C.W. DOOR WITH FACTORY MADE SINGLE LEAF FLUSH TYPE DOOR SHUTTERS USING 25MM PARTICLE BOARD AND STAMPED IS 3087/1985 TYPE-I WITH E TYPE TEAK WOOD BEADING BONDED WITH WATER RESISTING ADHESIVE	980 x 1980
D ₁	DOOR	C.W. DOOR FACTORY MADE PANELLED DOOR SHUTTERS USING 12MM PARTICLE BOARD STAMPED IS 3087/1985 TYPE I WITH TOP RAILS VERTICAL STYLES LOCK RAIL ETC, AS PER SPECIFICATION COVERED IN IS 1003/1977 WITH WATER RESISTING TREATMENT	920 x 1980
D ₂	DOOR	- DO -	820 x 1980
W ₁	WINDOW	C.W. WINDOWS WITH IRON BARS & FACTORY MADE C.W. SHUTTERS HALF PANELLED & HALF GLAZED	1800 x 1110
W ₂	WINDOW	- DO -	1815 x 1110
W ₃	WINDOW	C.W. WINDOWS WITH IRON BARS & FACTORY MADE C.W. SHUTTERS FULLY GLAZED	1300 x 750
W ₄	WINDOW	C.W. WINDOWS WITH IRON BARS & FACTORY MADE C.W. SHUTTERS HALF PANELLED & HALF GLAZED	600 x 1110
W ₅	WINDOW	C.W. WINDOWS WITH IRON BARS & FACTORY MADE C.W. SHUTTERS FULLY GLAZED	600 x 450
C		FACTORY MADE C.W. PANELLED SHUTTERS FOR CUPBOARD WITH C.W. FRAME LOCK & KEY	830 x 1980
C ₁		FACTORY MADE C.W. PANELLED WIRE MESH SHUTTERS WITH C.W. FRAME WITH LOCK & KEY	965 x 1980


- NOTE:**
1. ANODIZED ALUMINIUM FITTING WILL BE PROVIDED FOR ALL DOORS & WINDOWS.
 2. EACH ENTRANCE DOOR IS TO BE PROVIDED WITH DOOR CHAIN.
 3. EACH TENAMENT IS TO BE PROVIDED WITH BUZZER.
 4. ALL DIMENSIONS ARE IN M.M.

PLINTH AREA


G ROUND FLOOR	: 159 Sq. m
FIRST FLOOR	: 159 "
SECOND FLOOR	: 159 "
THIRD FLOOR	: 159 "
TOTAL	626 "

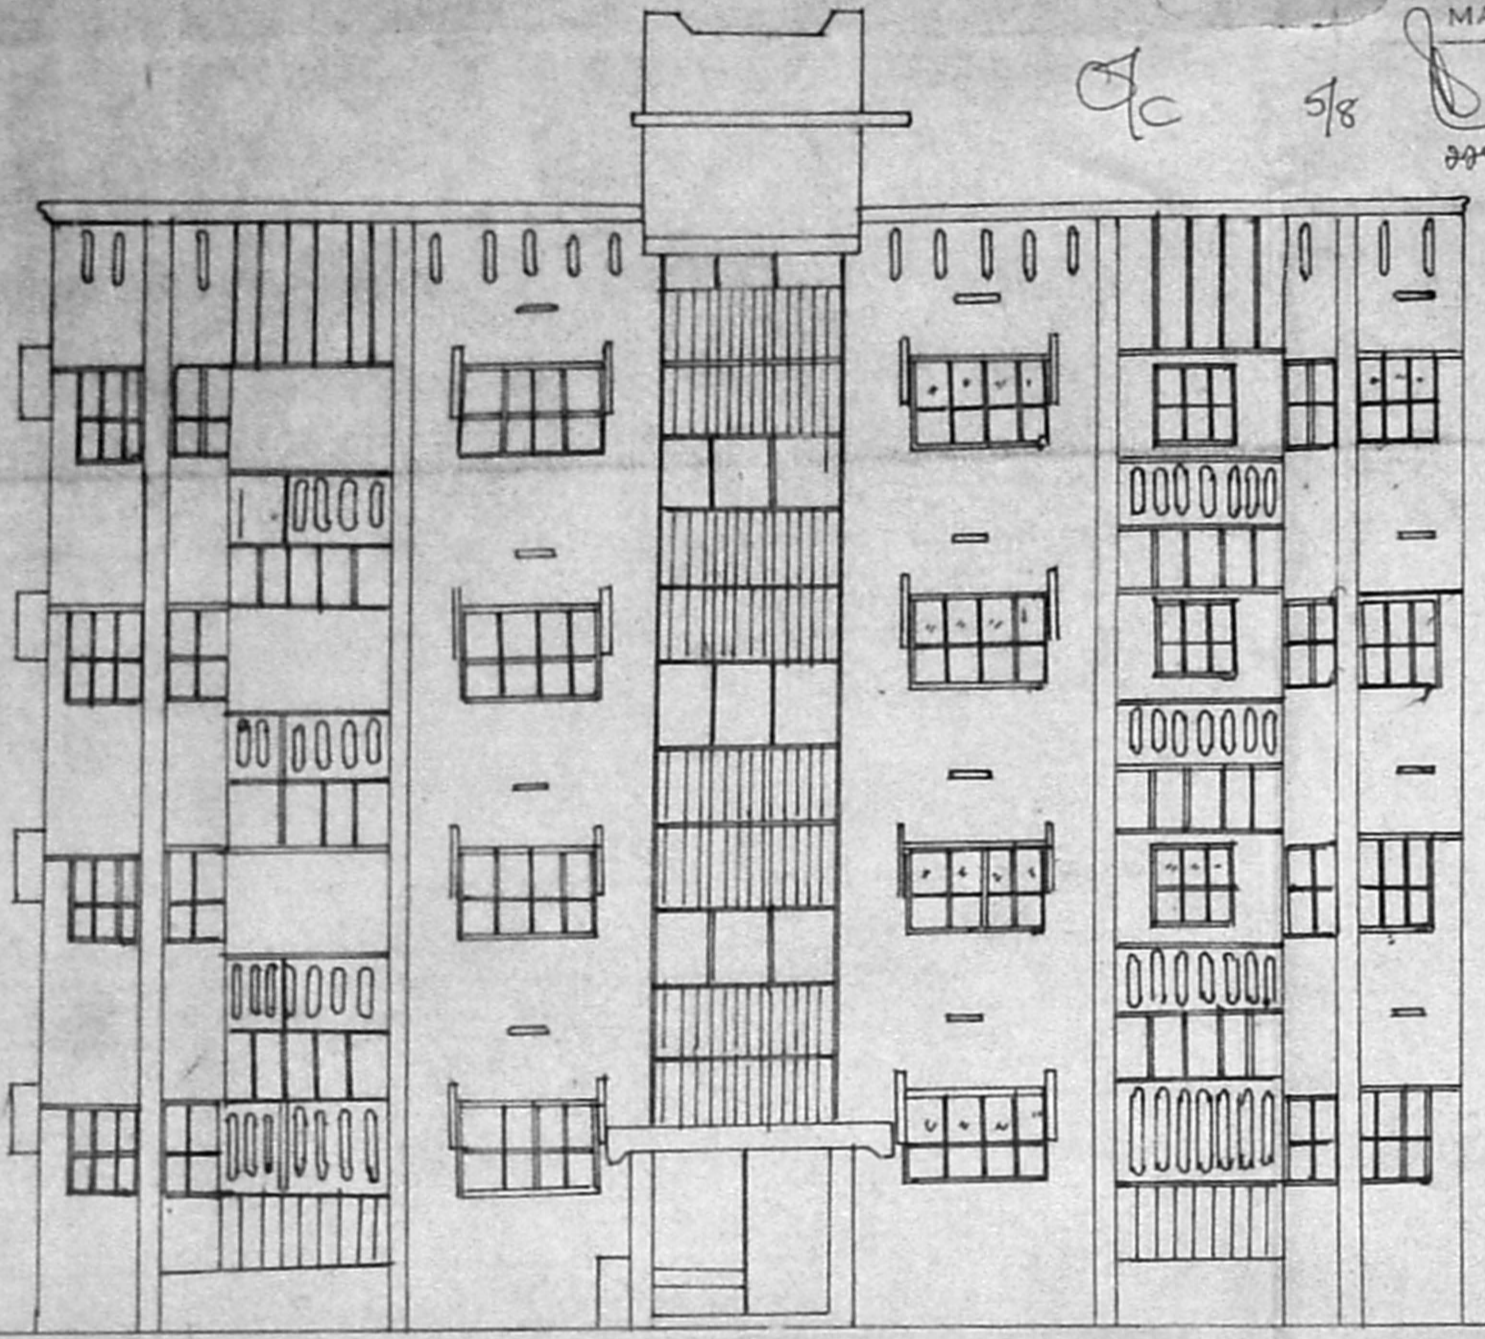


FRONT ELEVATION

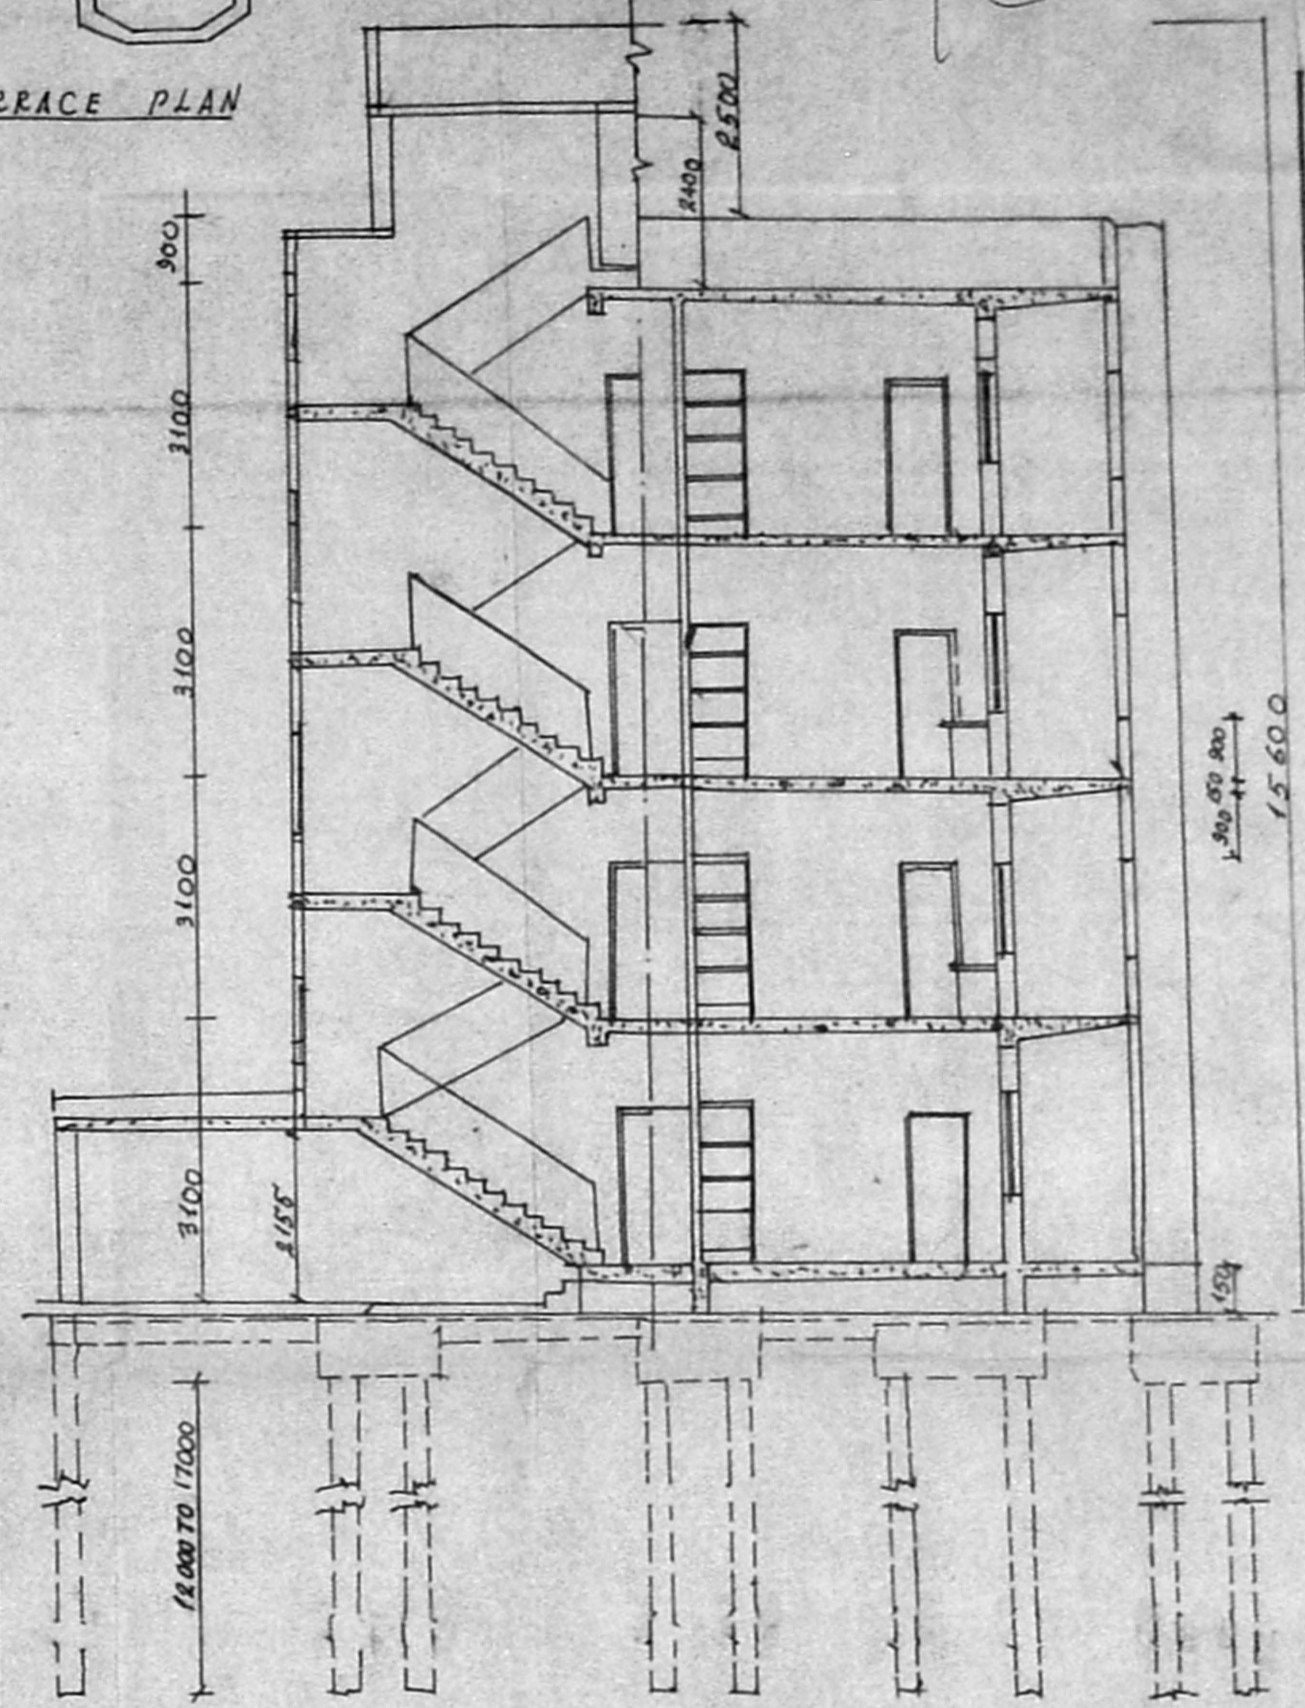

SECTION ON A-A

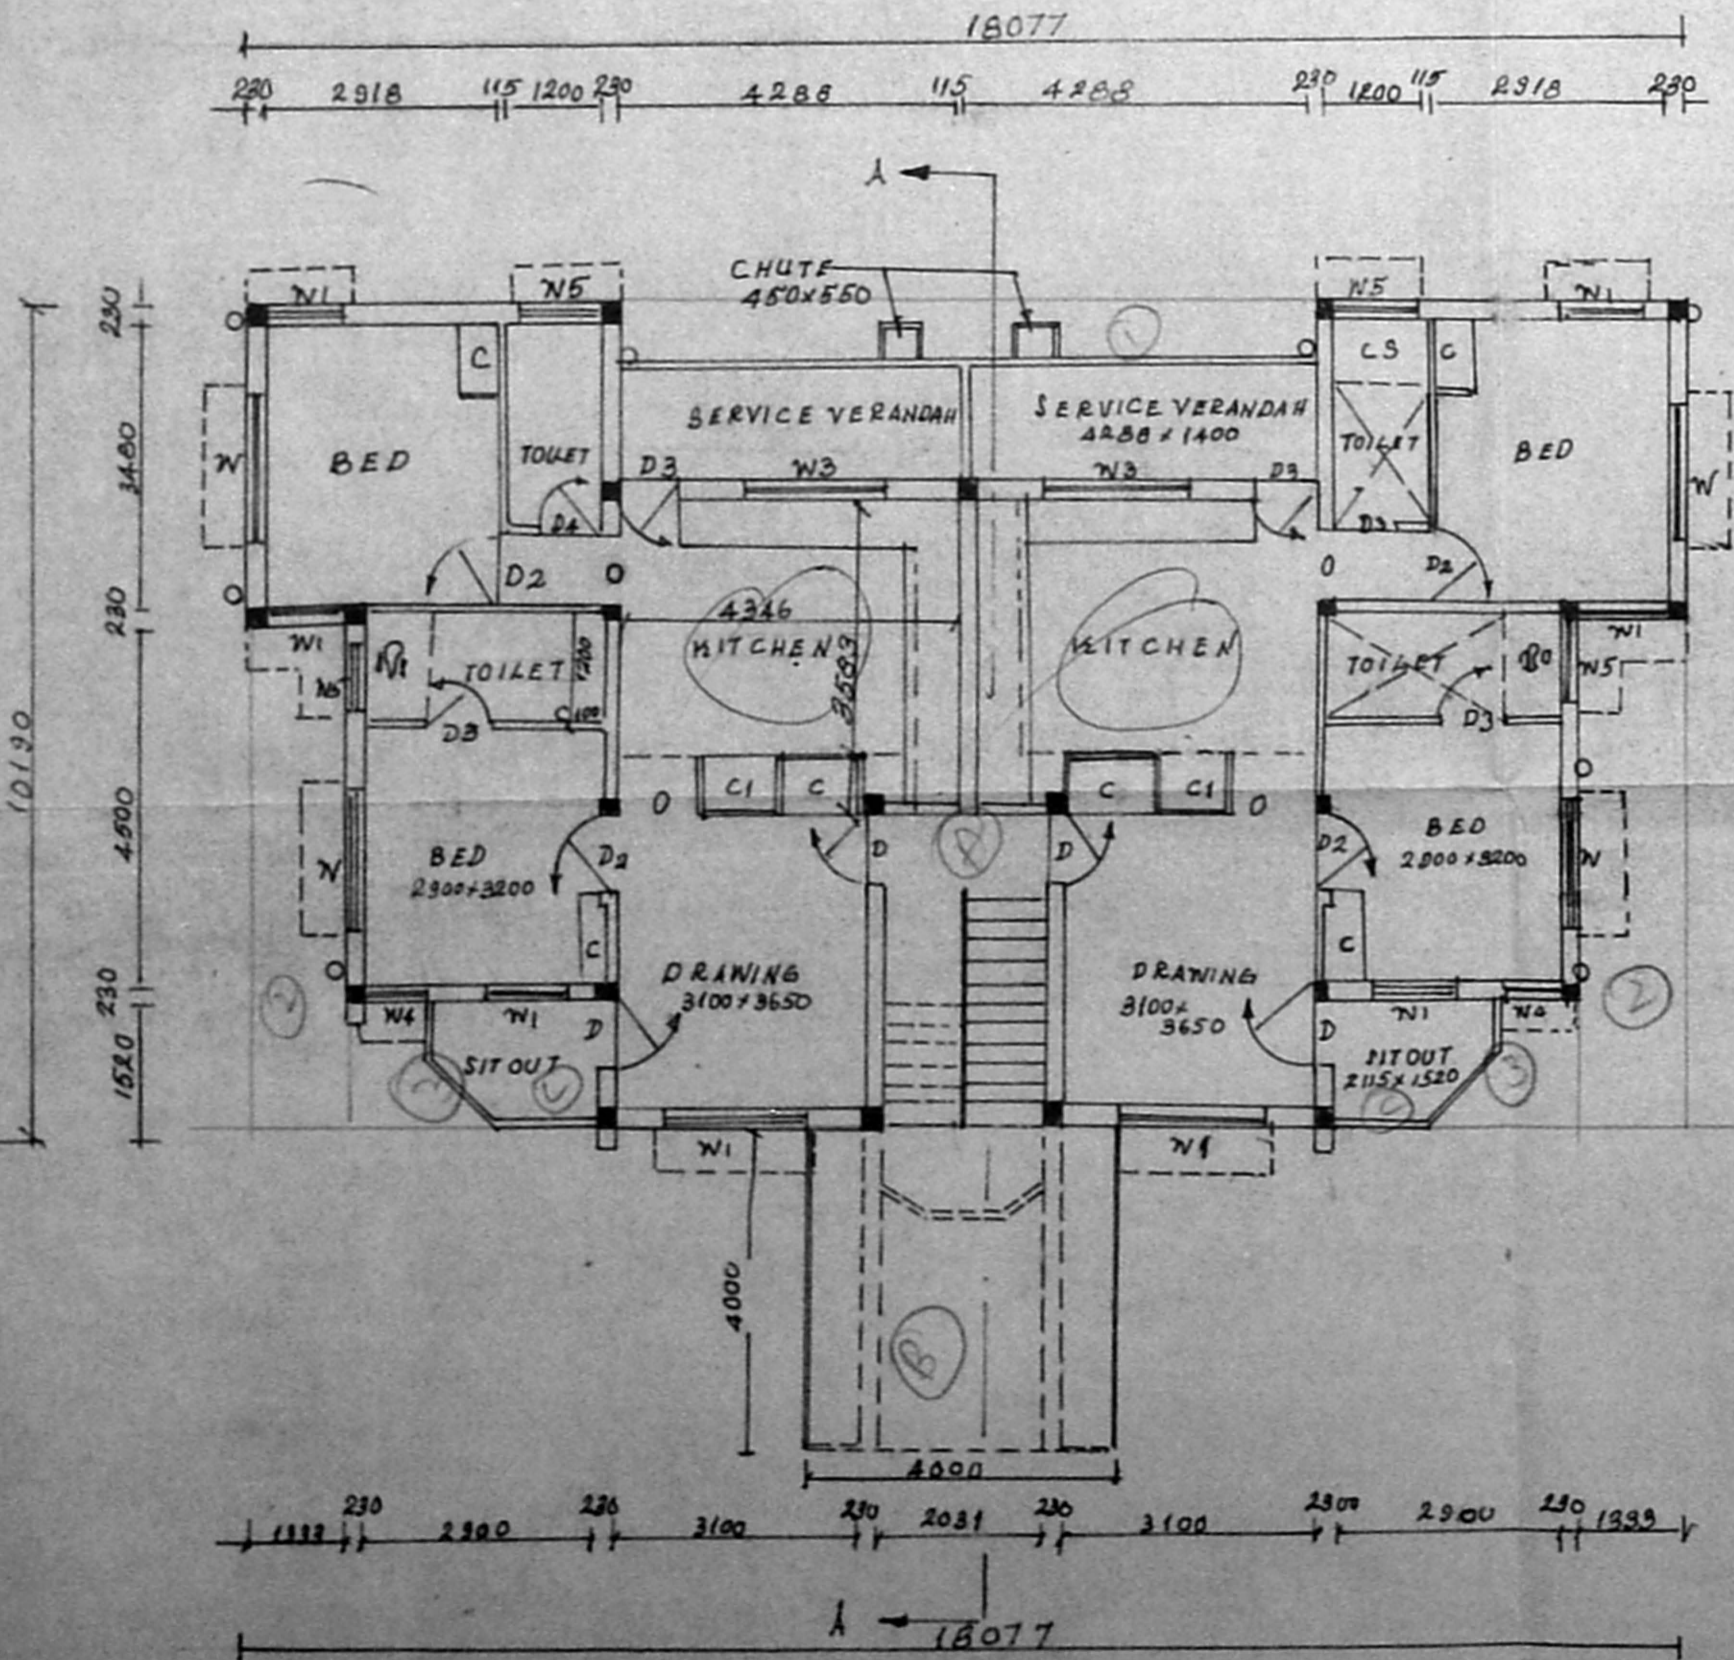

TYPICAL FLOOR PLAN
(G.F., F.F., S.F. & THIRD FLOOR)

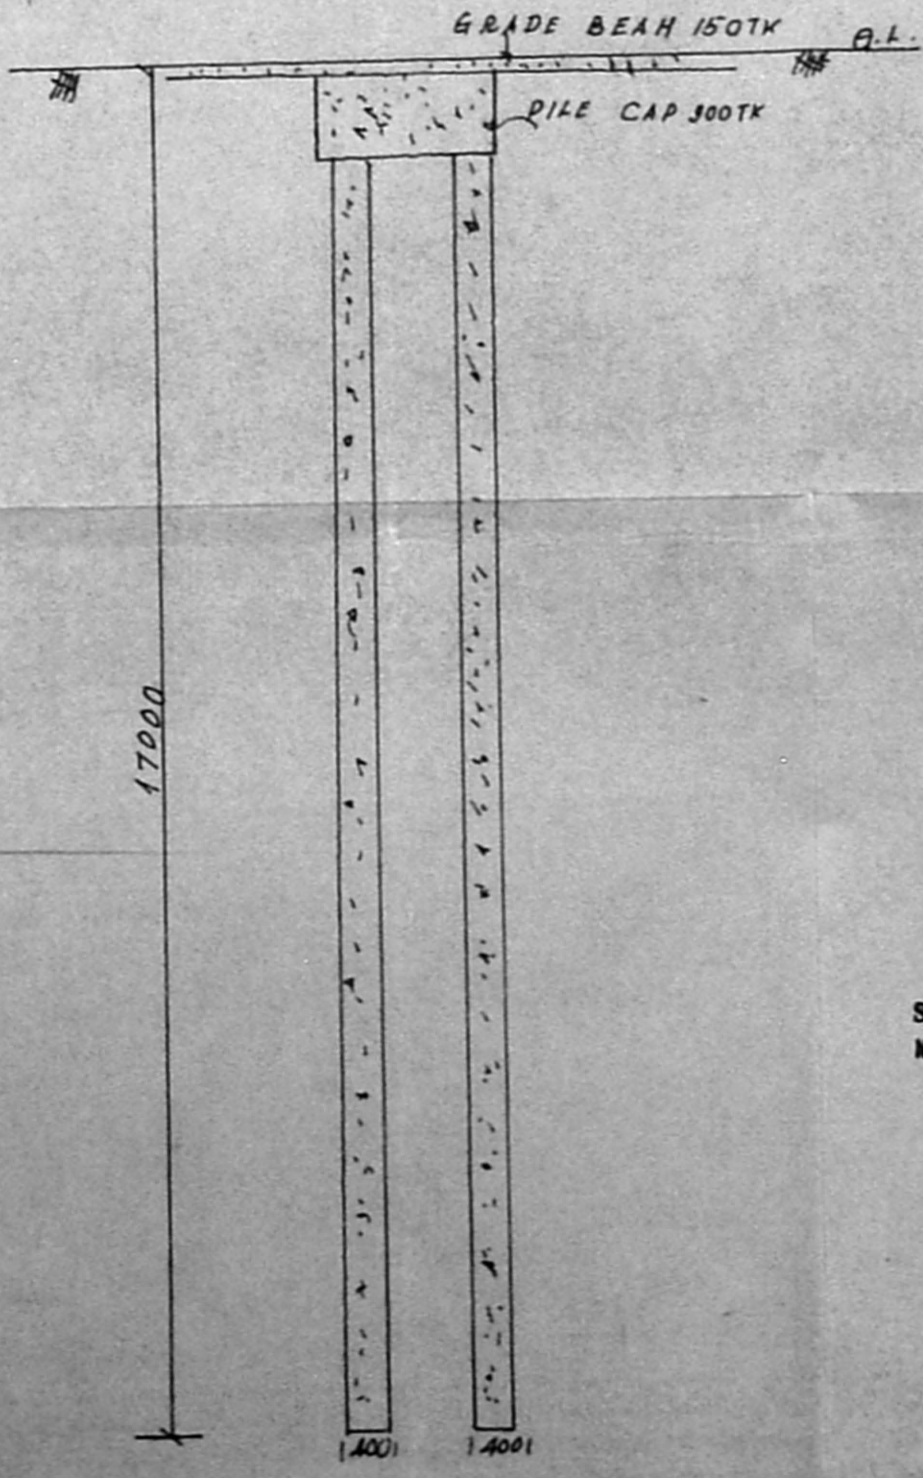

DETAILS OF DRIVEN CAST-IN-SITU PILE

Superintending Engineer (Civil-II)
NORTH MADRAS THERMAL POWER PROJECT
BNNORE, MADRAS-57.

S. SUDRAMANIAM, MARCH, A.I.A.,
ARCHITECT AND INTERIOR DESIGNER,
LICENSED CLASS-I, SURVIVOR NO: 90
8/1, VIDYARANYA, 11th MAIN ROAD,
KASTURIBAI NAGAR, ADYAR
LICENSED MATRONS NO: 920, TEL: 411305

DRAWN	TAMIL NADU ELECTRICITY BOARD
CHECKED	NORTH MADRAS THERMAL POWER PROJECT
TRACED	TYPE S QUARTERS


DIMENSIONS ARE GIVEN IN M.M.

(T) TYPE 10/10/1983


B/16521/188 F/23 dt. 10/5/83
 Planning Permit No.
APPROVED
 SUBJECT TO THE CONDITIONS IN
 D1 / THIS OFFICE LETTER,
 No. 2123/12-Date: 10/5/83

FOR MEMBER SECRETARY
 MADRAS METROPOLITAN
 DEVELOPMENT AUTHORITY
 MADRAS - 600 005.

MUDA B/PP NO.
 C.D. B/121297/52
 S.No. 13/1/52
 PATTI
 P.P. 1

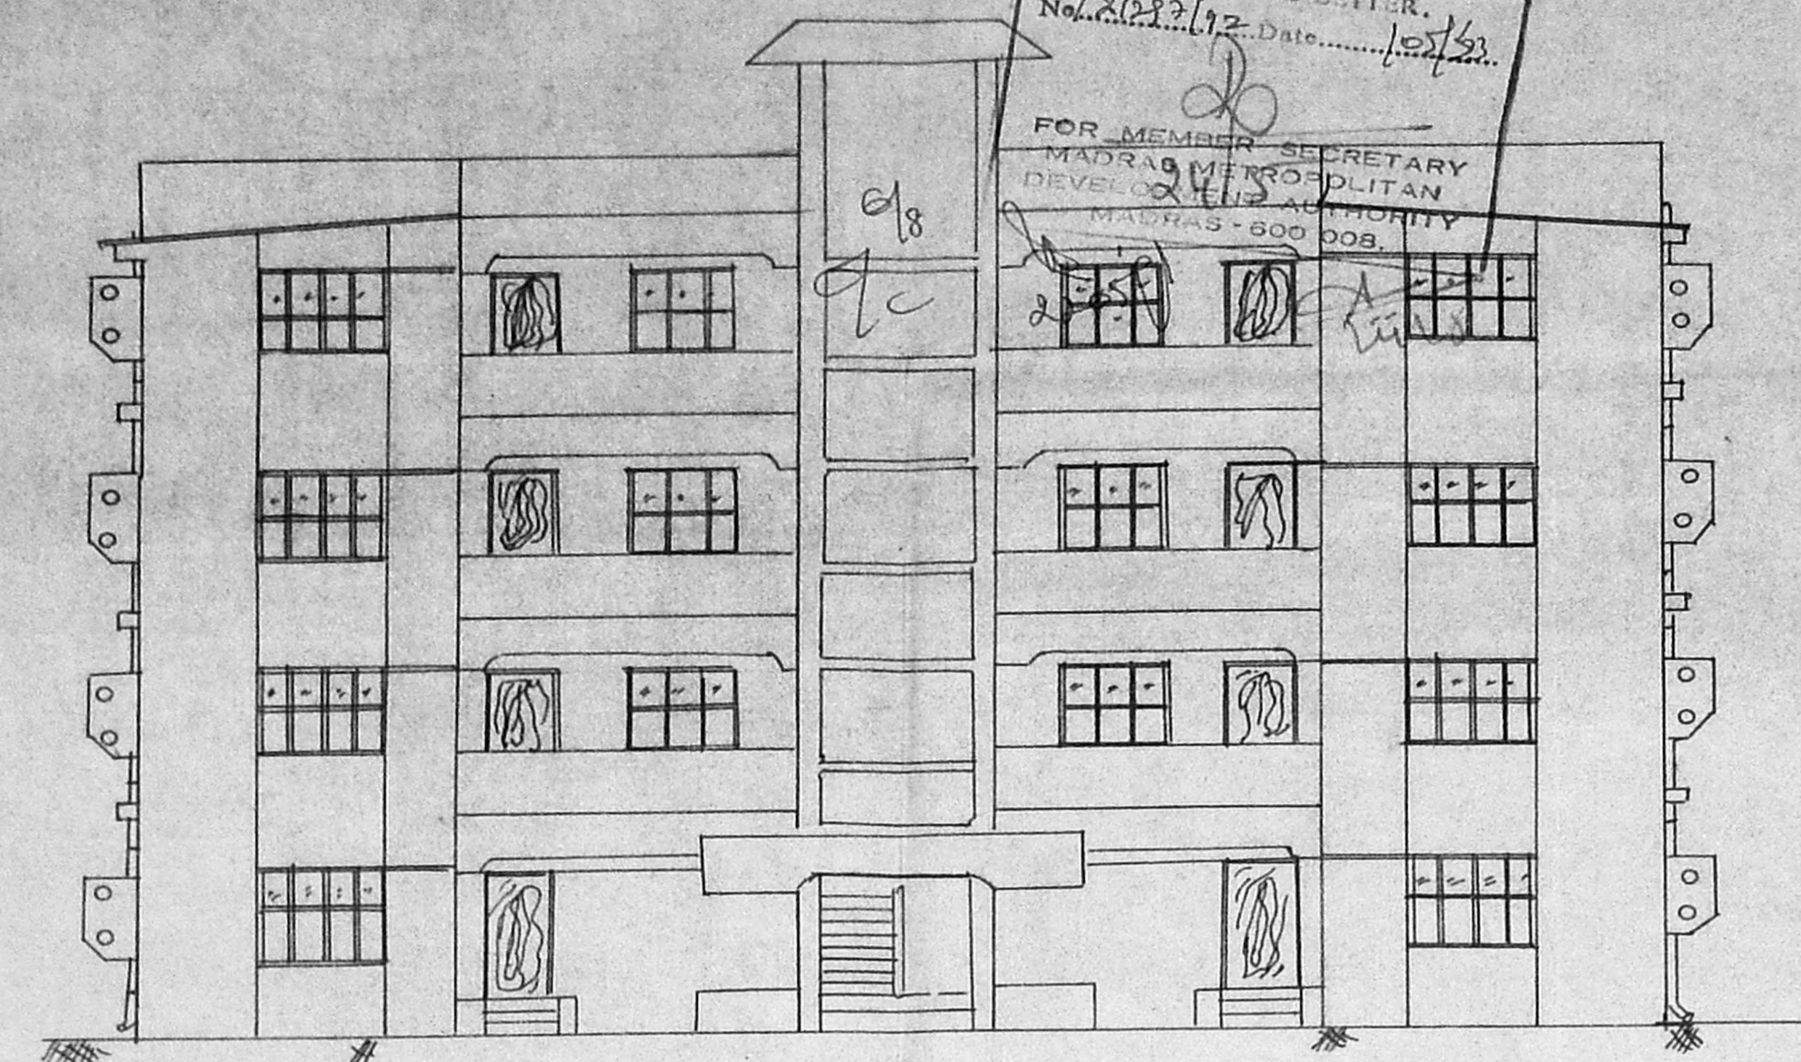

FRONT ELEVATION

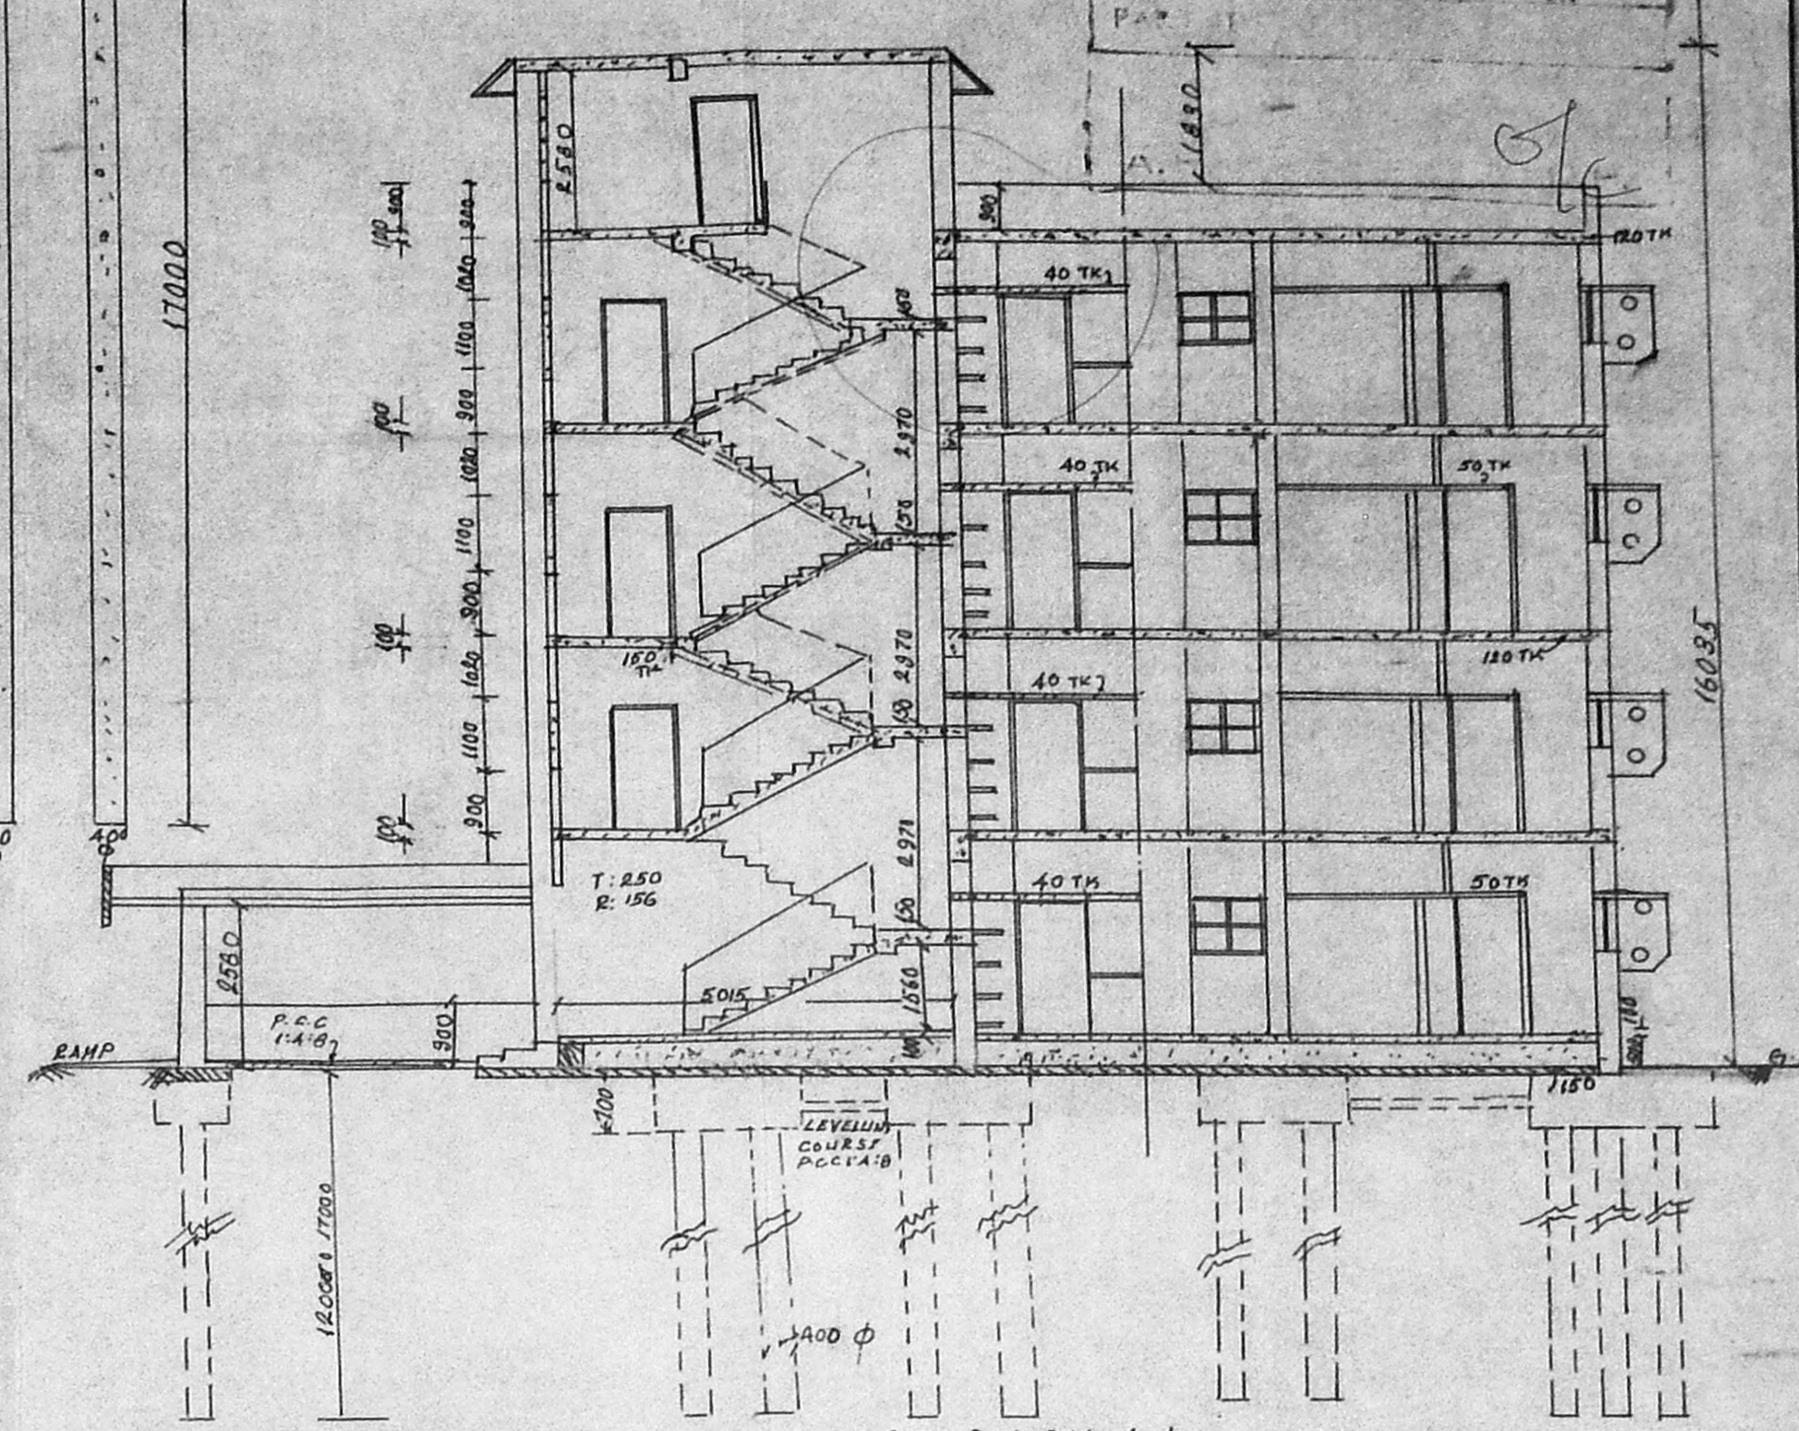

SECTION ON A-A

SCHEDULE OF DOORS & WINDOWS

D 990 x 1980 C.W. DOORS WITH FACTORY MADE SINGLE LEAF FLUSH DOOR SHUTTERS USING 25mm PARTICLE BOARD AND STAMPED IN B 3087/1985 TYPE WITH E TYPE TEAK WOOD BEADING BONDED WITH WATER RESISTING ADHESIVE FIXED TO C.W. DOOR FRAMES & FULLY THREADED G.I. SCREWS SINGLE LEAF

D2 920 x 1980 C.W. DOOR FACTORY MADE PANELLED SHUTTERS USING 12mm PARTICLE BOARD & STAMPED IN B 3087/1985 TYPE WITH TOP RAILS VERTICALS STYLES LOCK RAIL ETC AS PER SPE. COVERED IN I.S. 1003/1977 WITH WATER RESISTING TREATMENT.

D3 820 x 1980 - do -

W 1800 x 1100 C.W. WINDOW WITH IRON BARS & FACTORY MADE C.W. SHUTTERS HALF PANELLED HALF GLAZED

W7 900 x 750 - do -

W3 1800 x 750 C.W. WINDOW WITH IRON BARS & FACTORY MADE C.W. SHUTTERS FULLY GLAZED

C2 1980 x 1100 FACTORY MADE C.W. PANELLED SHUTTERS FOR C-B WITH C.W. FRAME & LOCK & KEY


C3 1980 x 900 - do -

C4 1980 x 900 - do - WIRE MESH SHUTTERS


Y 900 x 600 C.W. VENTILATORS FULLY GLAZED WITH C.W. FRAMES

Y1 820 x 450 - do -

PLINTH AREA
 GROUND FLOOR : 231 sqm
 FIRST FLOOR : 231 "
 SECOND FLOOR : 231 "
 THIRD FLOOR : 231 "
 TOTAL : 924 "

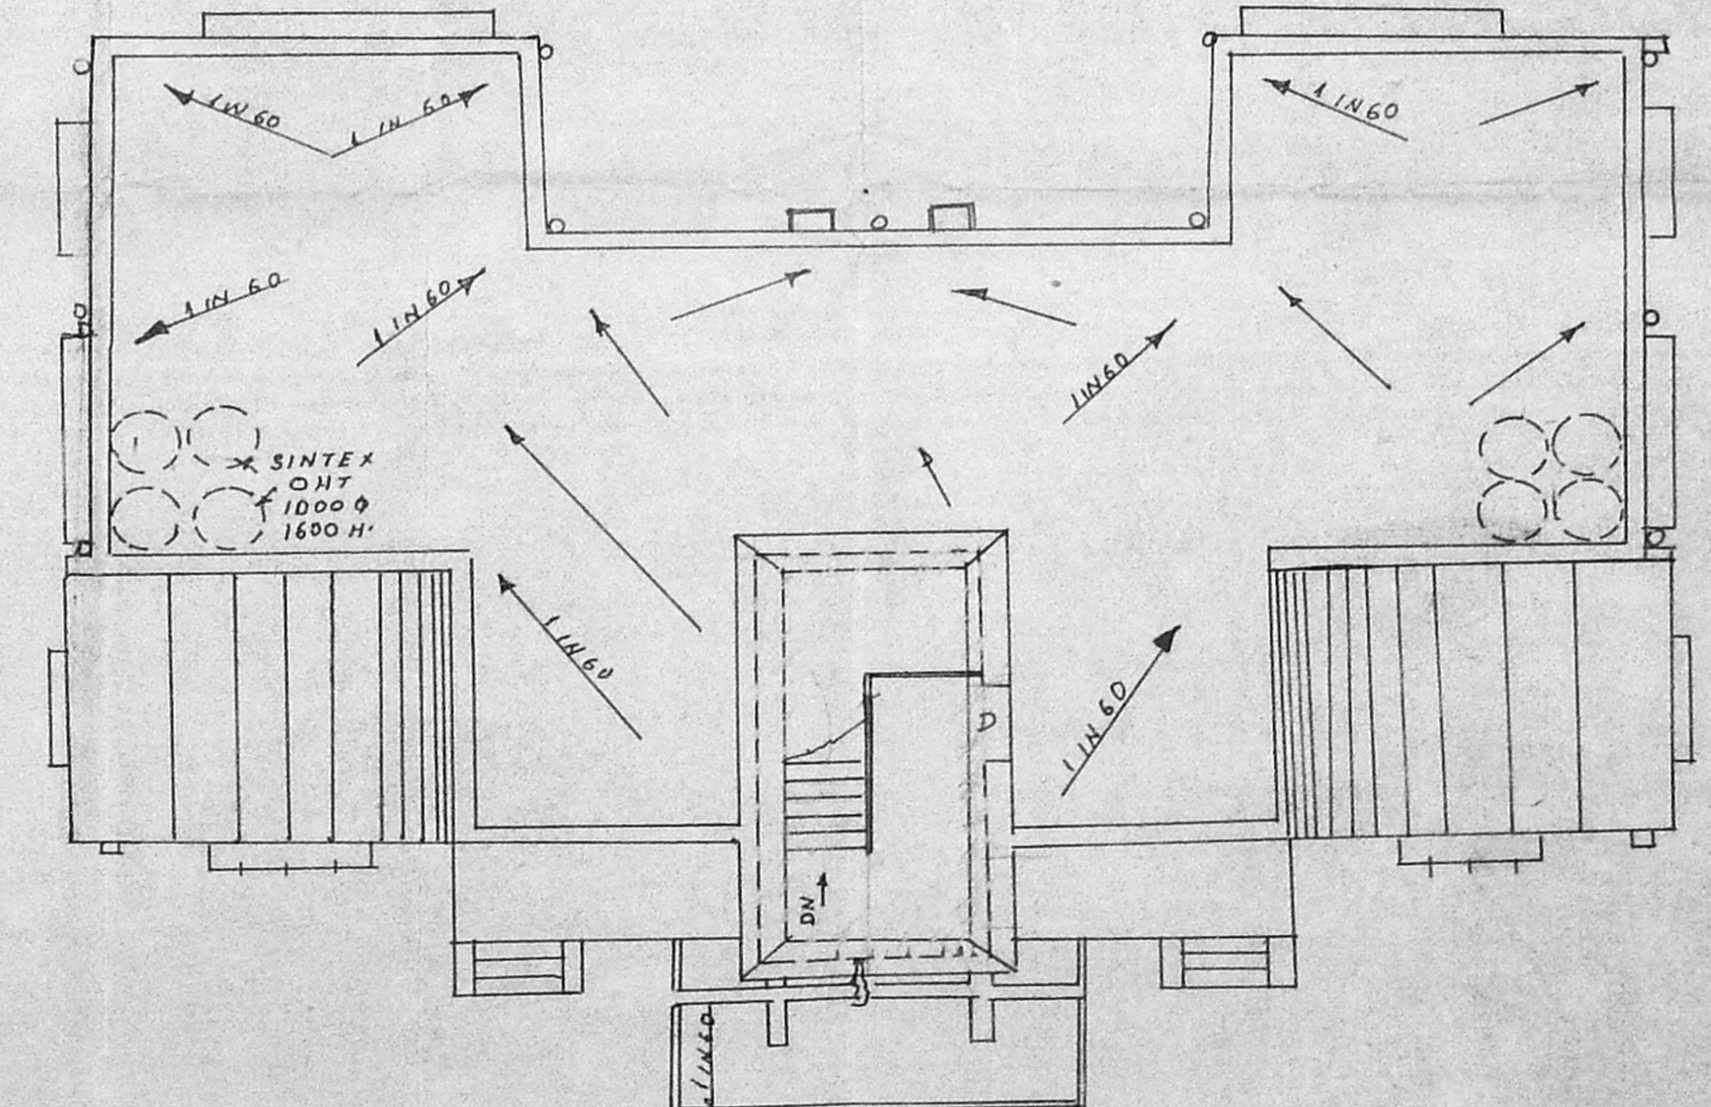

TERRACE FLOOR PLAN

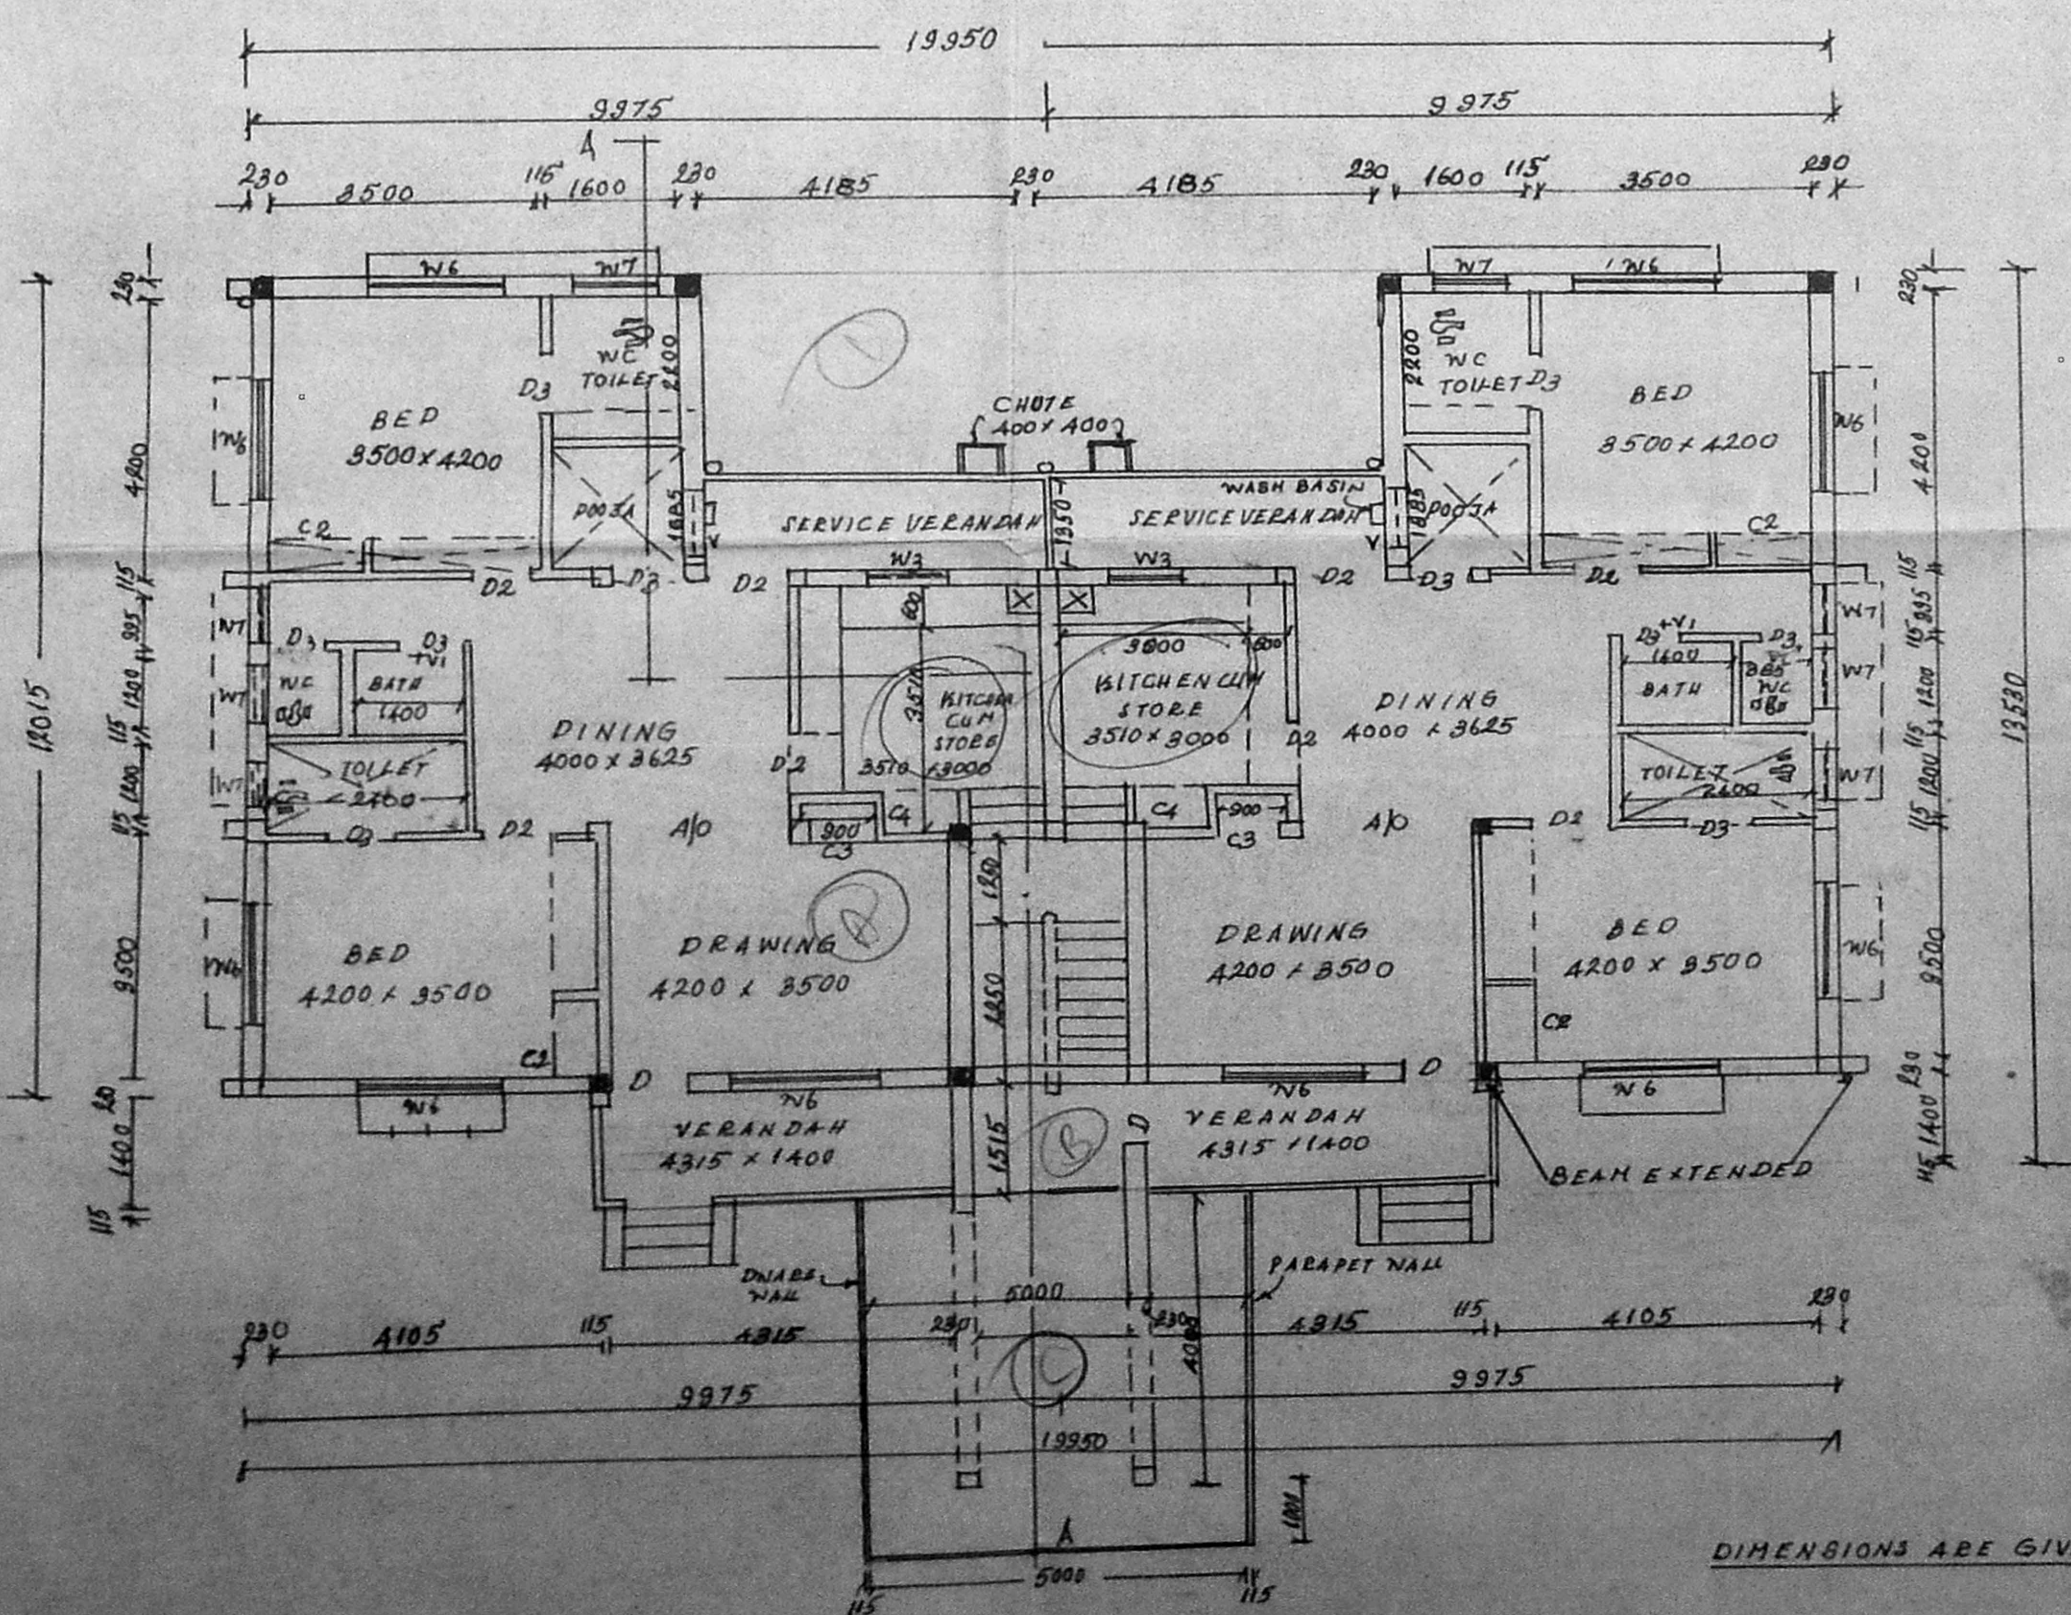

HALF GROUND FLOOR PLAN & HALF OTHER FLOORS PLAN
 C.G.F. F.F. S.F. & THIRD FLOOR

Superintending Engineer Civil-11
 NORTH MADRAS THERMAL POWER PROJECT
 ENNORE, MADRAS-57.
 OWNER

S. Subramaniam, M.Arch., A.I.I.A.,
 ARCHITECT AND INTERIOR DESIGNER
 LICENCED CLASS-I, SURVEYOR NO: 99
 8/1, VIDYARANYA, 11th MAIN ROAD,
 KASTURIBAI NAGAR, ADYAR
 MADRAS-600 020, TEL: 411305
 LICENCED SURVEYOR

DRAWN	TAMILNADU ELECTRICITY BOARD	DES. NO.
CHECKED	NORTH MADRAS THERMAL POWER PROJECT	DATE
PASSED	T' TYPE QUARTERS	SCALE
		1:100

MMDA TB/PP NO. 711
 C.No. B/2.1297/2
 Approved
 Part I
 Part II

Planning Permit No. B/16521/188 H/93
APPROVED
 SUBJECT TO THE CONDITIONS IN THIS OFFICE LETTER.
 Date: 15/11/92
 FOR MEMBER SECRETARY
 MADRAS METROPOLITAN
 DEVELOPMENT AUTHORITY
 MADRAS - 600 005

Planning Permit No. B/16521/188 H/93
APPROVED
 SUBJECT TO THE CONDITIONS IN THIS OFFICE LETTER.
 Date: 15/11/92
 FOR MEMBER SECRETARY
 MADRAS METROPOLITAN
 DEVELOPMENT AUTHORITY
 MADRAS - 600 005

ELEVATION OF PORCH WITH CURVE BETWEEN COLUMNS (1:50)



DETAILS OF SHON TILES ARRANGEMENT (NTS)

GRILL COVERED OPEN YARD A.P. D.P.


ELEVATION (1:100)

SECTION A B (1:100)

SECTION C C (1:50)

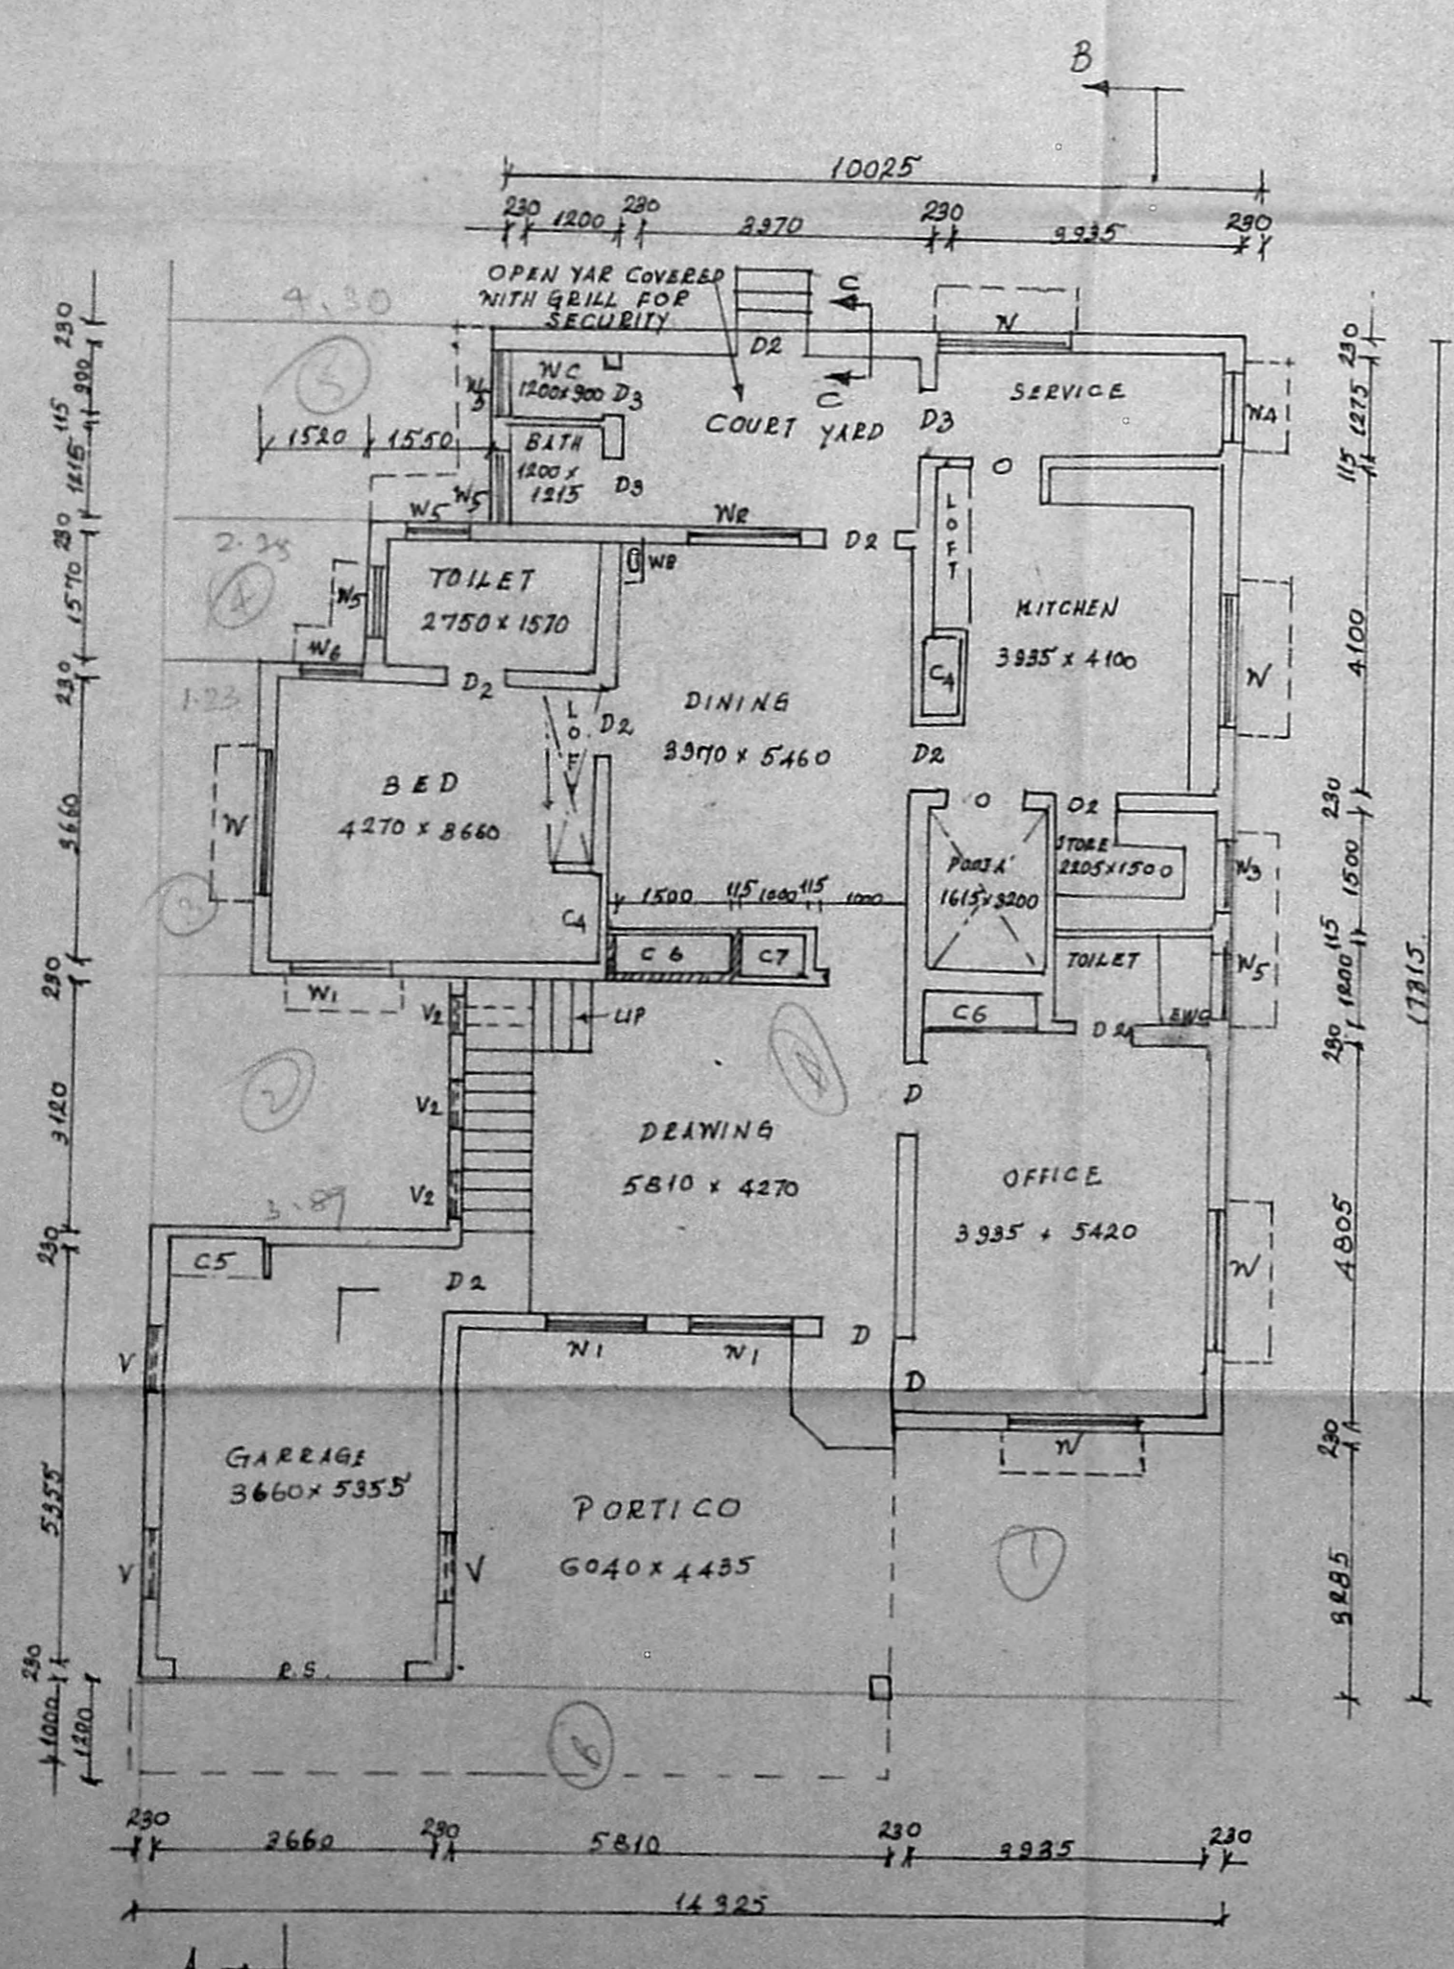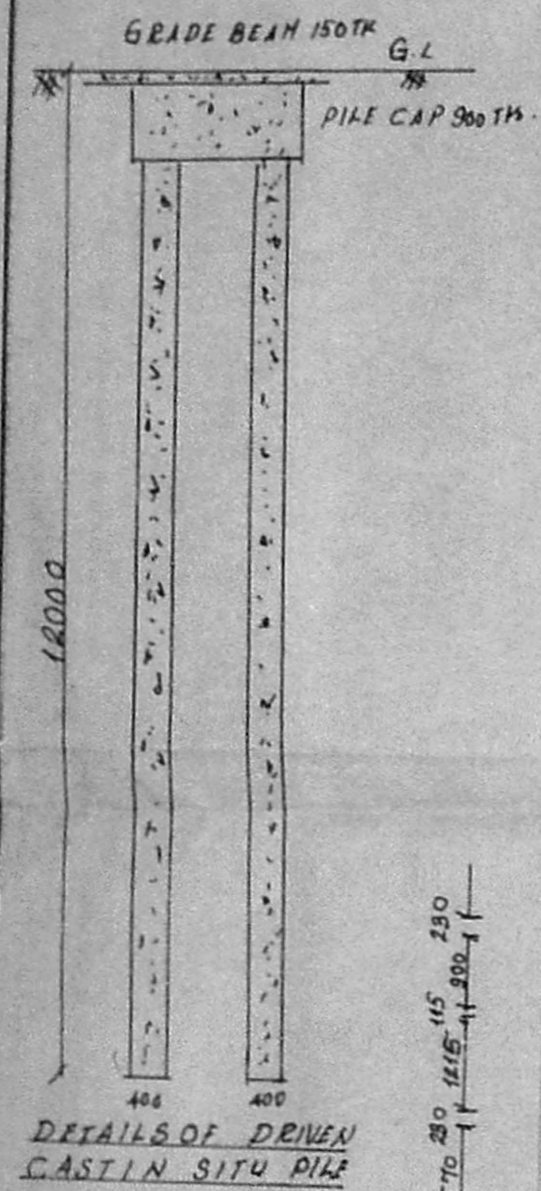

GROUND FLOOR PLAN (1:100)

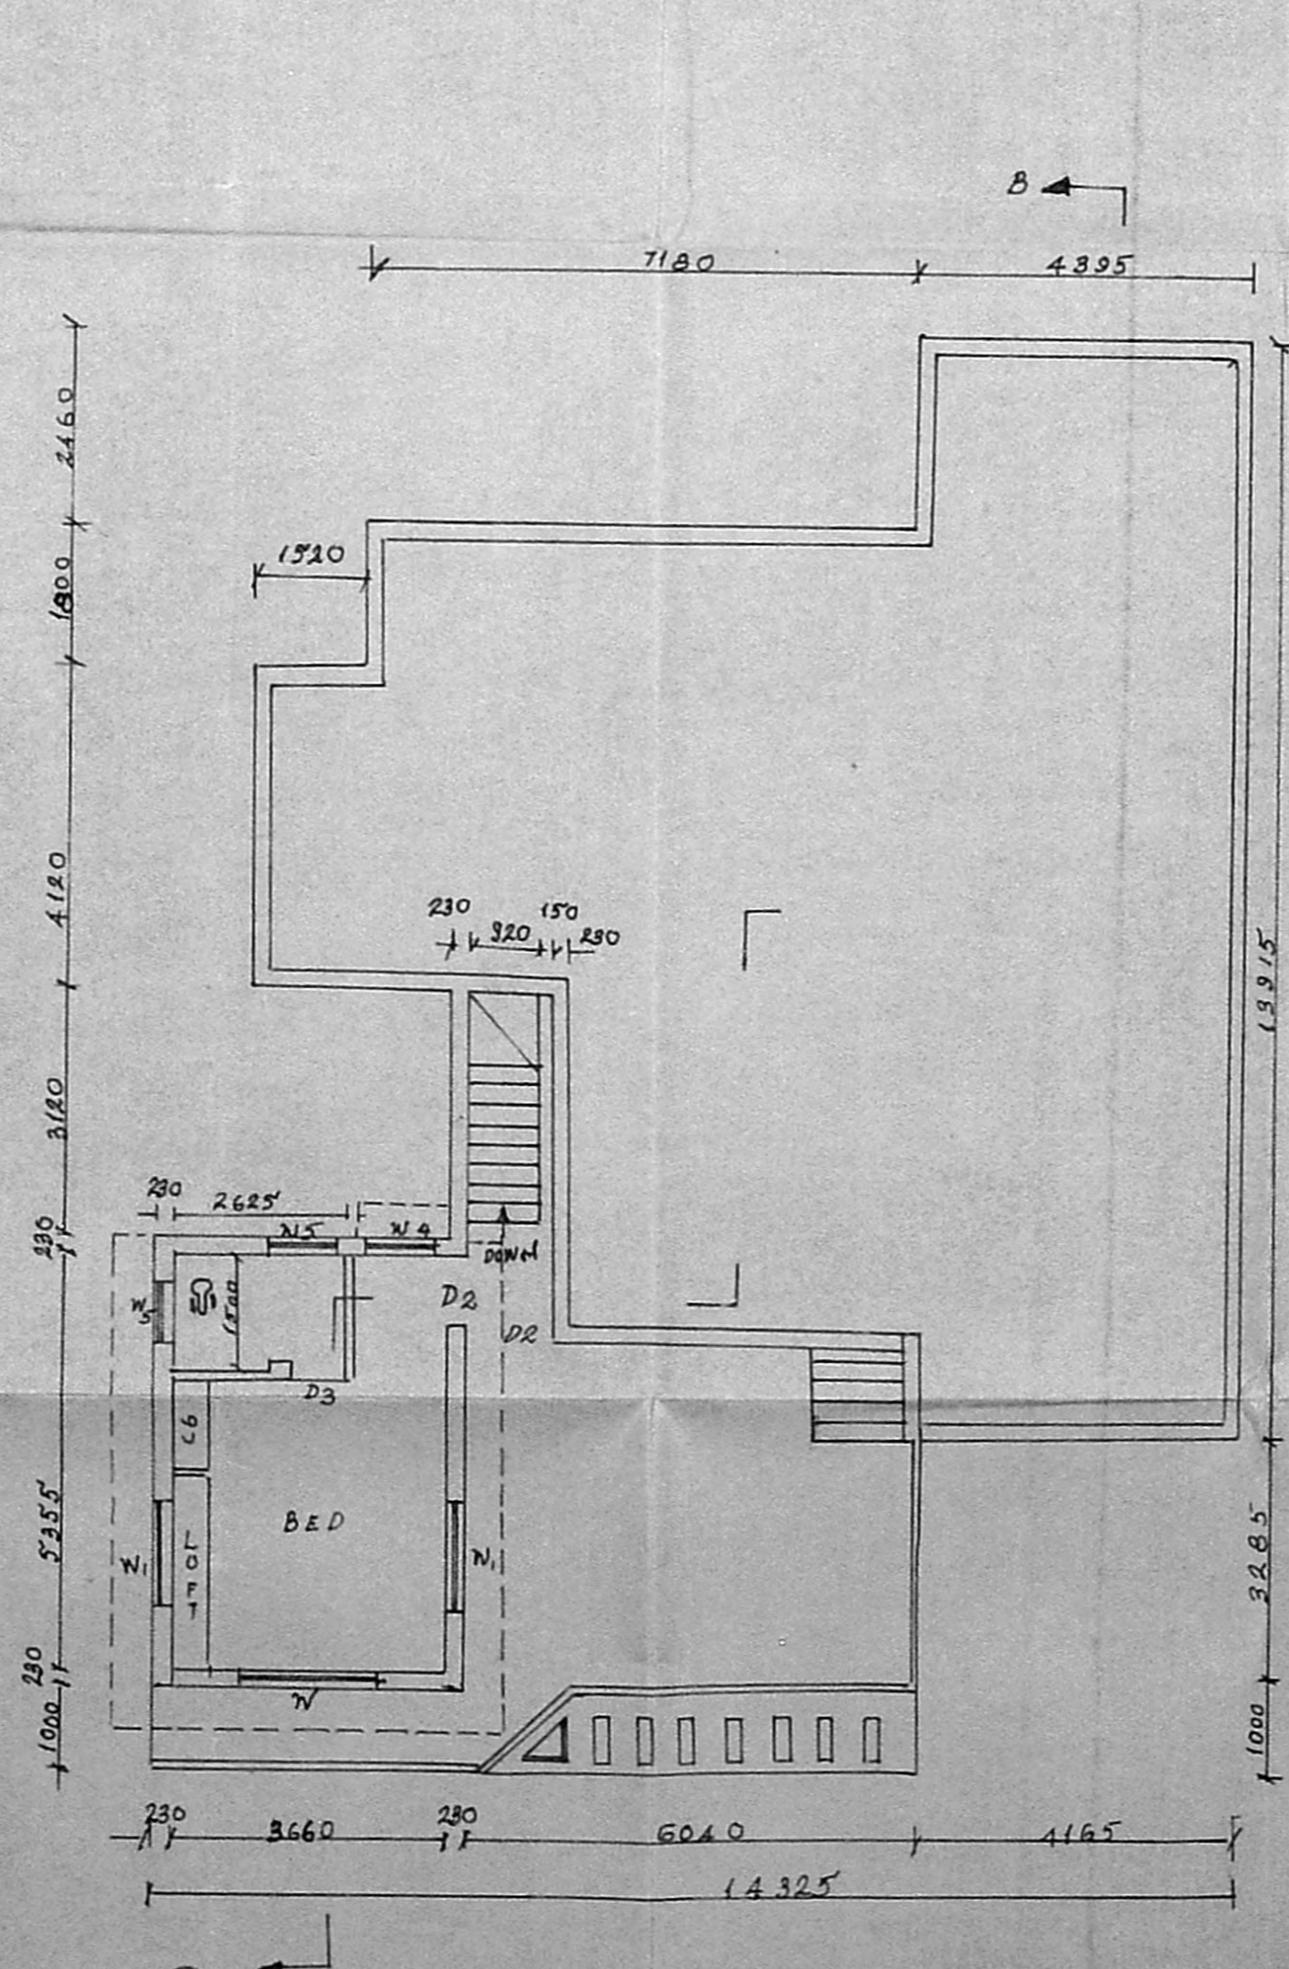

FIRST FLOOR PLAN (1:100)

SCHEDULE OF DOORS & WINDOWS

D 980x1000 C.W. DOOR WITH FACTORY MADE SINGLE LEAF FLUSH TYPE SHUTTERS USING 25 mm TH PARTICLE BOARD STAMPED IS 9087/1985 WITH 'E' TYPE T.W. BEADING BONDED WITH WATER RESISTING ADHESIVE

D2 920 x 1980 C.W. DOOR FACTORY MADE PANNELLED SHUTTER USING 25 mm PARTICLES BOARD STAMPED IS 9087/1985 TYPE WITH TOP RAIL, VERTICALS, TILES, LOCK RAIL ETC. AS PER SPECIFICATION COVERED IN IS 1008/1977 WITH WATER RESISTING TREATMENT

D3 620 x 1980 - DO -

W 1800 x 1100 C.W. WINDOW WITH IRON BASE & FACTORY MADE SHUTTERS FULLY GLAZED.

W1 1850 x 1100 C.W. WINDOW WITH IRON BARS & FACTORY MADE SHUTTERS HALF PANNELLED & HALF GLAZED

W4 600 x 1100 - DO -

W5 600 x 450 C.W. WINDOWS FULLY GLAZED

V 900 x 600 VENTILATOR GLAZED

R3 2050 x 450 ROLLING SHUTTER SIZE

V2 500 x 1100 FIXED ARCH TYPE VENTILATOR GLAZED


C5 1000 x 1980 OPEN CUP BOARD WITH R-OCTIERS

C6 1500 x 1980 CUP BOARD WITH PANNELLED SHUTTERS

C7 1000 x 1980 CUP BOARD WITH BOTTOM PANNELLED TOP GLAZED SHUTTERS

C4 580 x 1980 CUP BOARD WITH WIRE MESH SHUTTERS

PLINTH AREA
 GROUND FLOOR: 176.59 m²
 FIRST FLOOR: 24 m²
 TOTAL: 200 m²

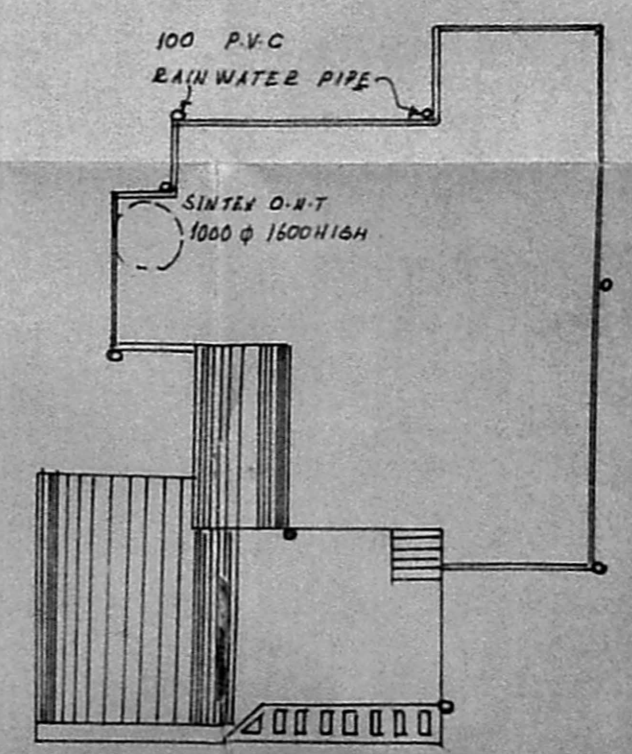

TERRACE PLAN (1:200)

Superintending Engineer (Civil-II)
 NORTH MADRAS THERMAL POWER PROJECT
 ENNORE MADRAS-57.
 OWNER

S. Subramaniam, V. Arch. A.I.I.A.
 ARCHITECT AND INTERIOR DESIGNER
 LICENCED CLASS-I. SURVEYOR NO: 90
 8/1, VIDYARANYA, 11th MAIN ROAD,
 KASTURIBAI NAGAR, ADYAR
 MADRAS-600 029. TEL: 411303

DR	TAMIL NADU ELECTRICITY BOARD	DRG. NO
DRAWN		
CHECKED	NORTH MADRAS THERMAL POWER PROJECT	DATE
PASSED	U TYPE QUARTERS	SCALE AS NOTED

DIMENSION ARE GIVEN IN MM

V

MMDA 'B' / PP NO. B/1/2125/7/30

APR. 1958

SWISS PATTENT

PART II

A.P. D.P.

B/1/CS21/188 H/93 dt 10/5/58


Planning Permit No.

APPROVED


SUBJECT TO THE CONDITIONS IN THIS OFFICE LETTER.

Dt 21/2/57


FOR MEMBER SECRETARY MADRAS METRO. SOCIETY

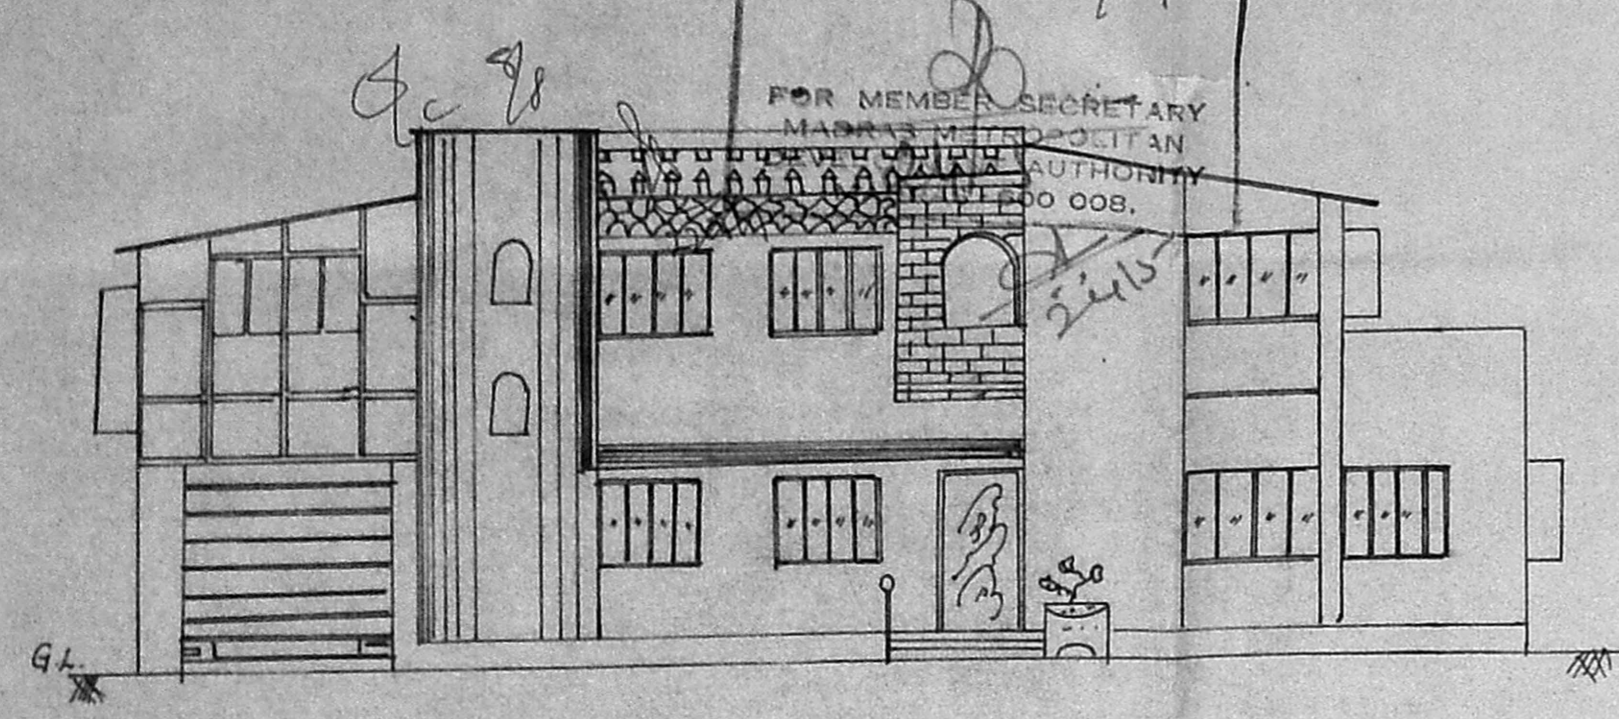

FRONT ELEVATION

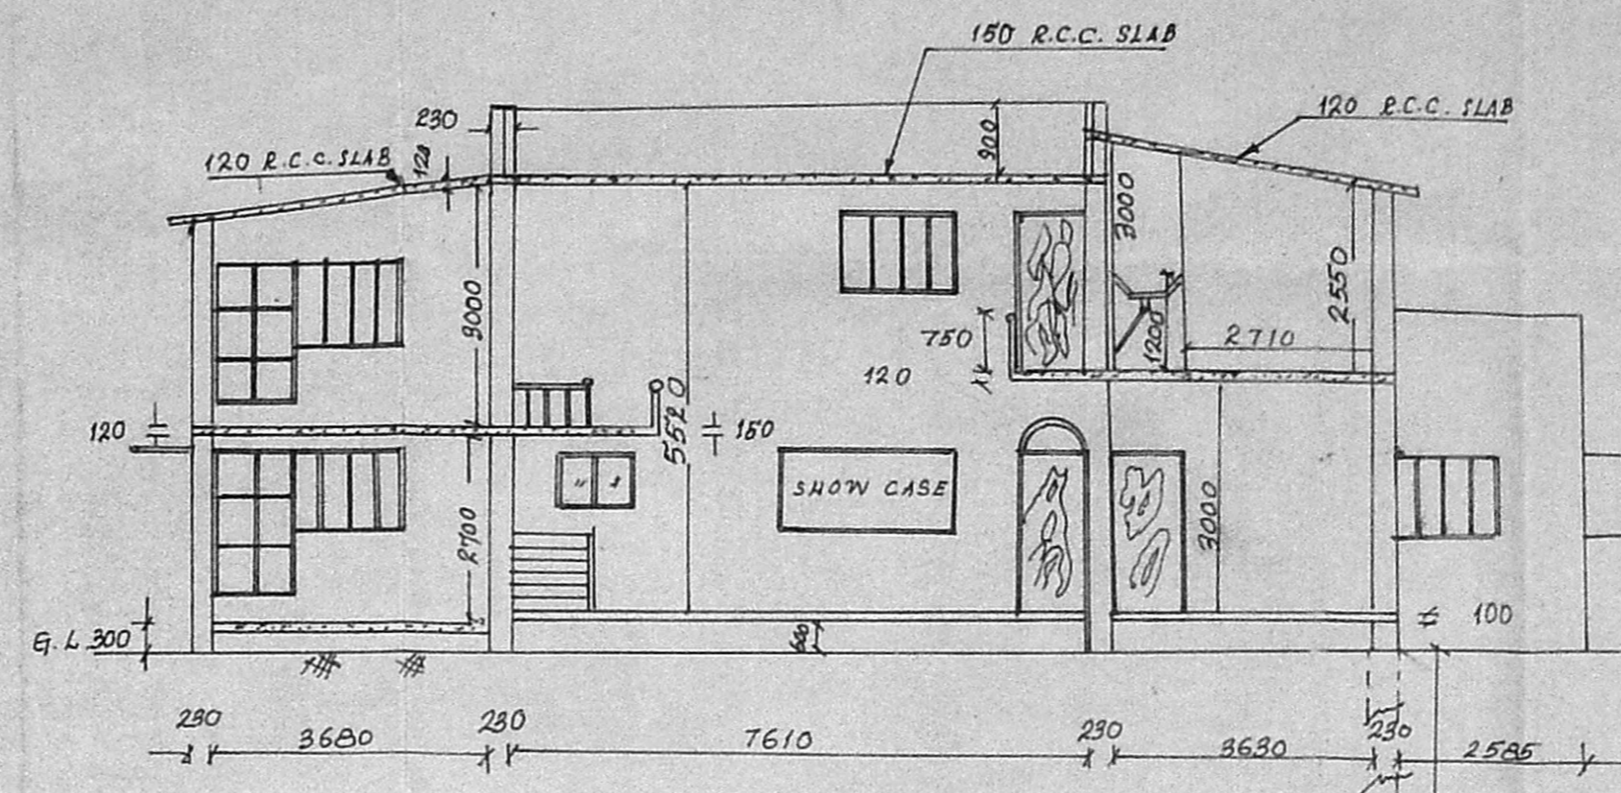


SECTION ON AA

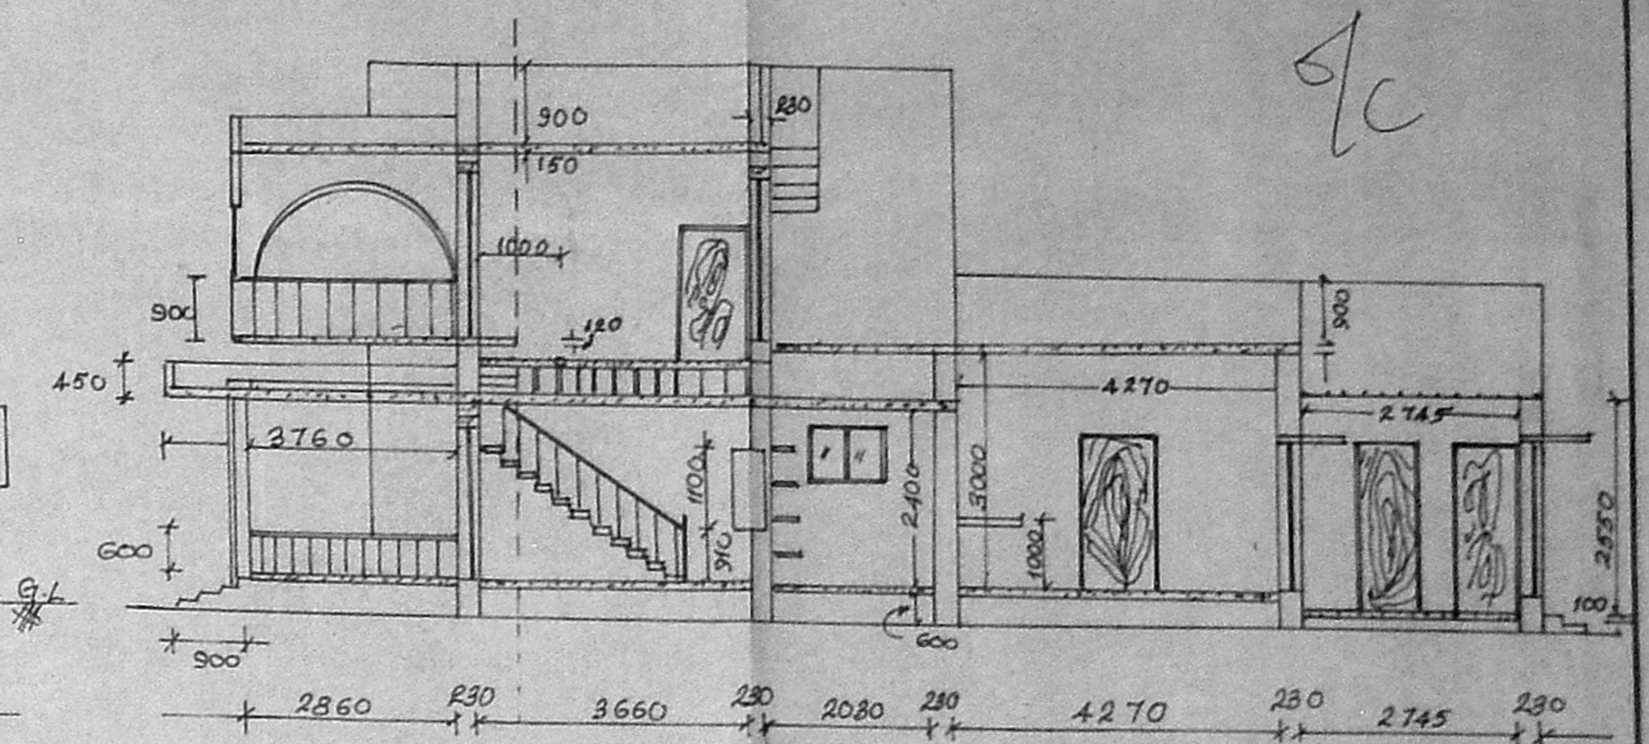


SECTION ON BB

SCHEDULE FOR DOORS & WINDOWS

- D5 990 x 2185 C.WOOD DOOR WITH FACTORY MADE SINGLE LEAF FLUSH TYPE SHUTTER USING 825/711 PARTICLE BOARD & STAMPED 1:3805/11935 WITH E TYPE TEAR WOOD BRADING BONDED WITH WATER RESISTING ADHESIVE
- D2 920 x 1380 C.WOOD FACTORY MADE PANELLED SHUTTER USING 12mm PARTICLE BOARD STAMPED 15308/11935 TYPE WITH TOP RAIL VERTICAL STILES LOCK RAILS ETC AS PER SPEC. COVERED IN 15308/11935 WITH W.R.T.
- D3 820 x 1980 - do -
- W 1800 x 1980 C.W WINDOW WITH IRON BARS & FACTORY MADE SHUTTERS FULLY GLAZED
- W1 1350 x 1110 - do -
- W3 1800 x 750 - do -
- W7 900 x 750 - do -
- WE 1600 x 1980 FULLY PANELLED SHUTTERS WITH COUNTRY SHUTTERS
- CUK 10 1600 x 1980 - GLAZED
- C2 1100 x 1380 FACTORY MADE C.W PANELLED SHUTTERS FOR CUP BOARD WITH C.W FRAME WITH LOCK & KEY
- C3 300 x 1880 - do -
- V3 450 x 600 ARCH TYPE VENTILATOR FIXED TYPE
- S 2400 x 2250 STEEL SHUTTERS FOR CAR SHED
- SHOW CASE 2115 x 1110 FULLY GLAZED WITH C.W SHUTTERS

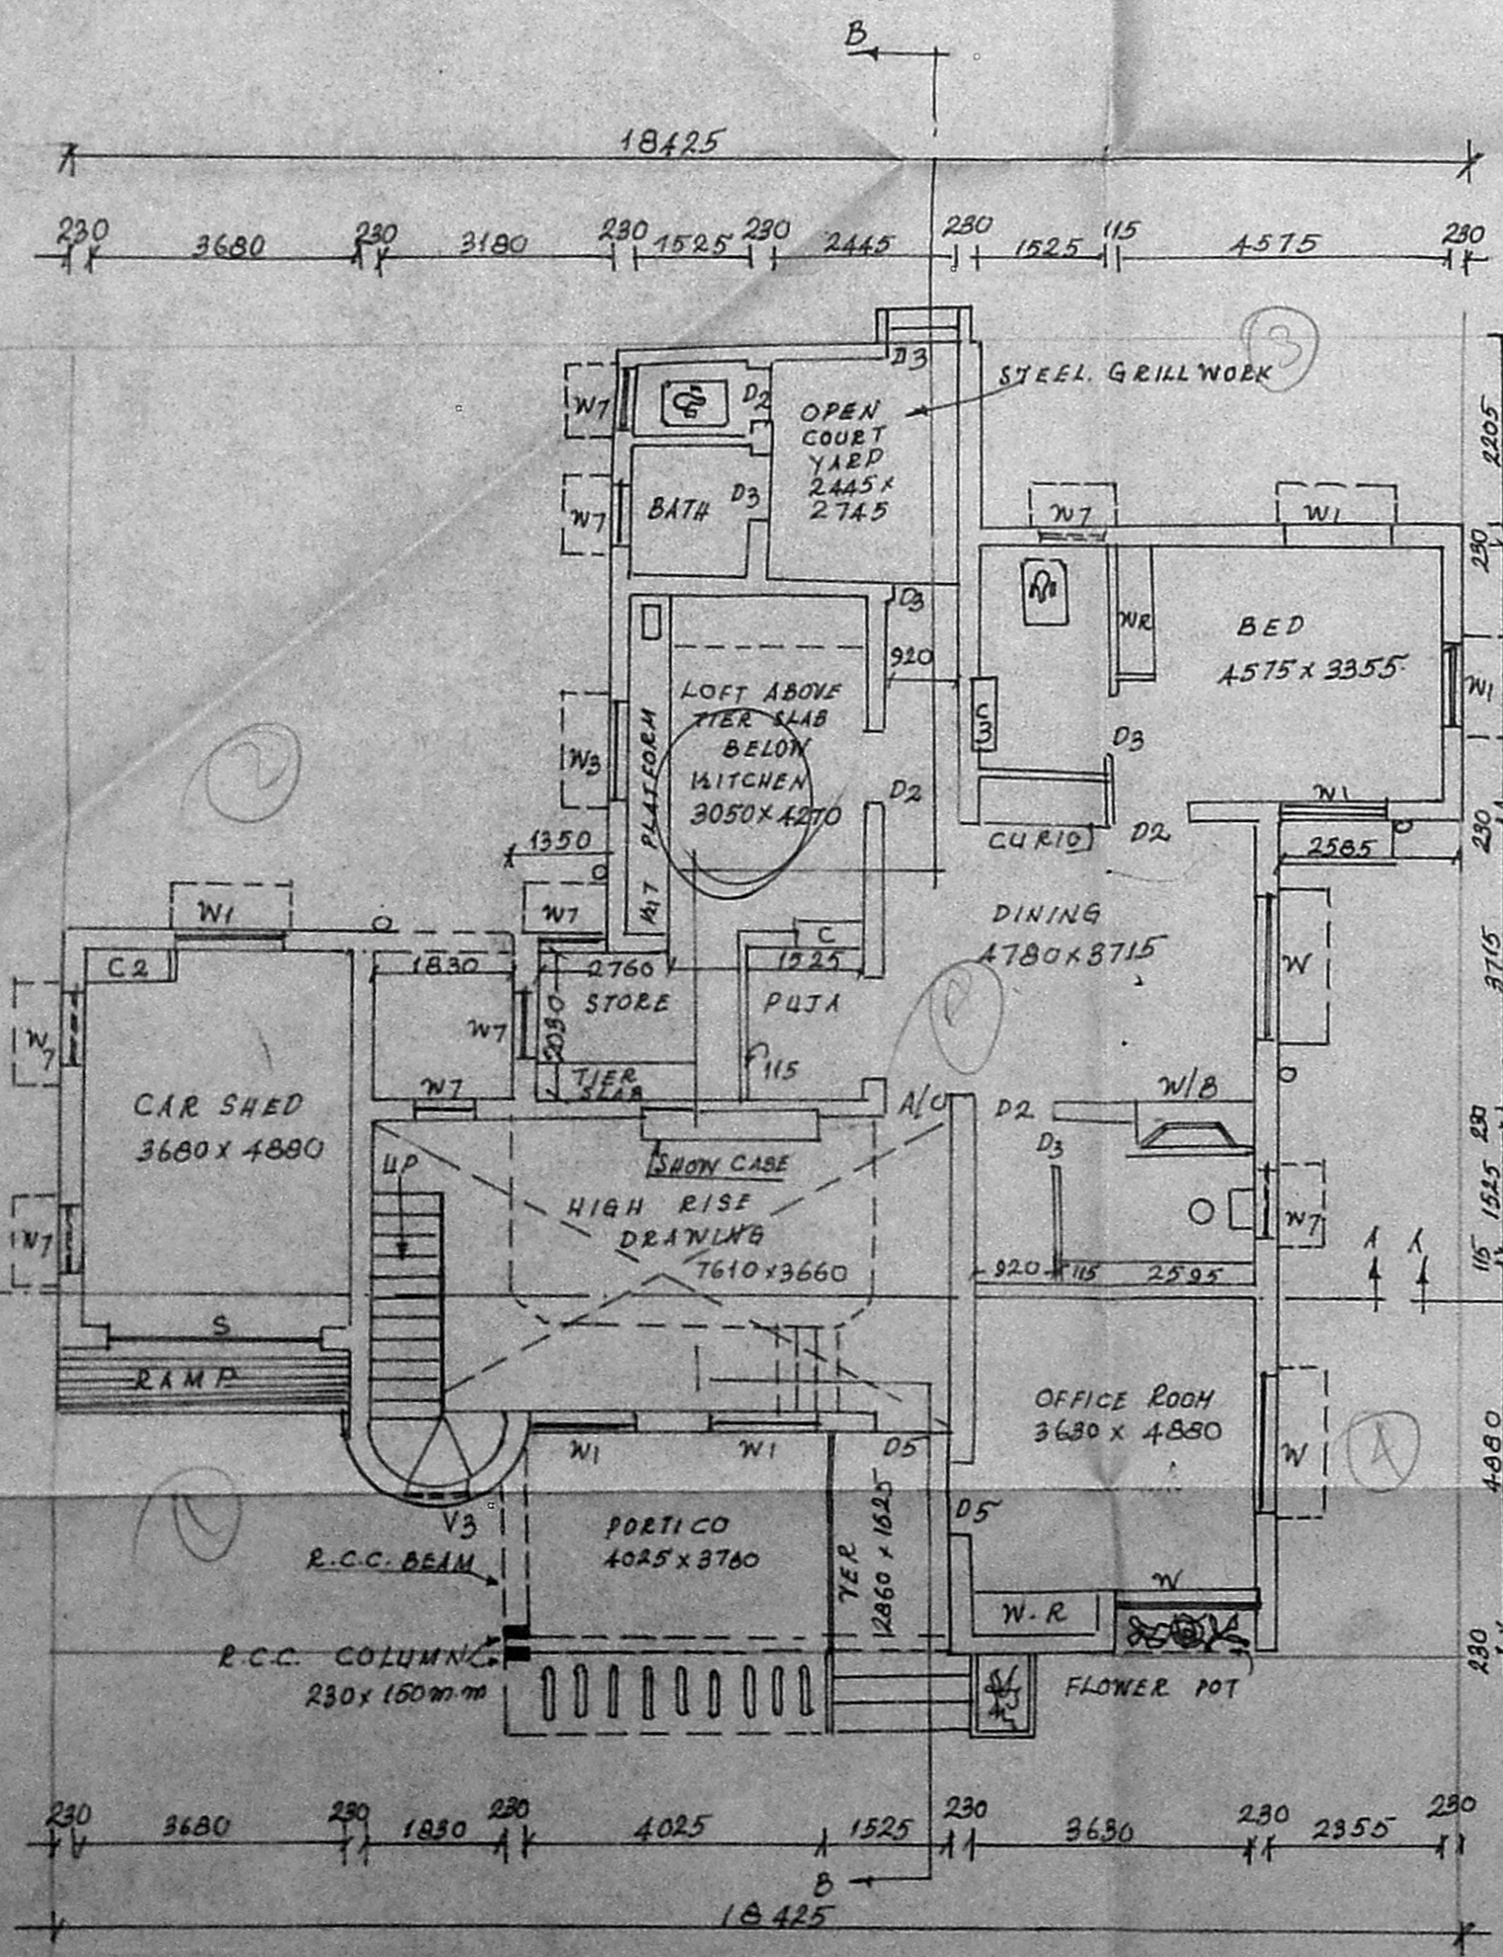

GROUND FLOOR PLAN

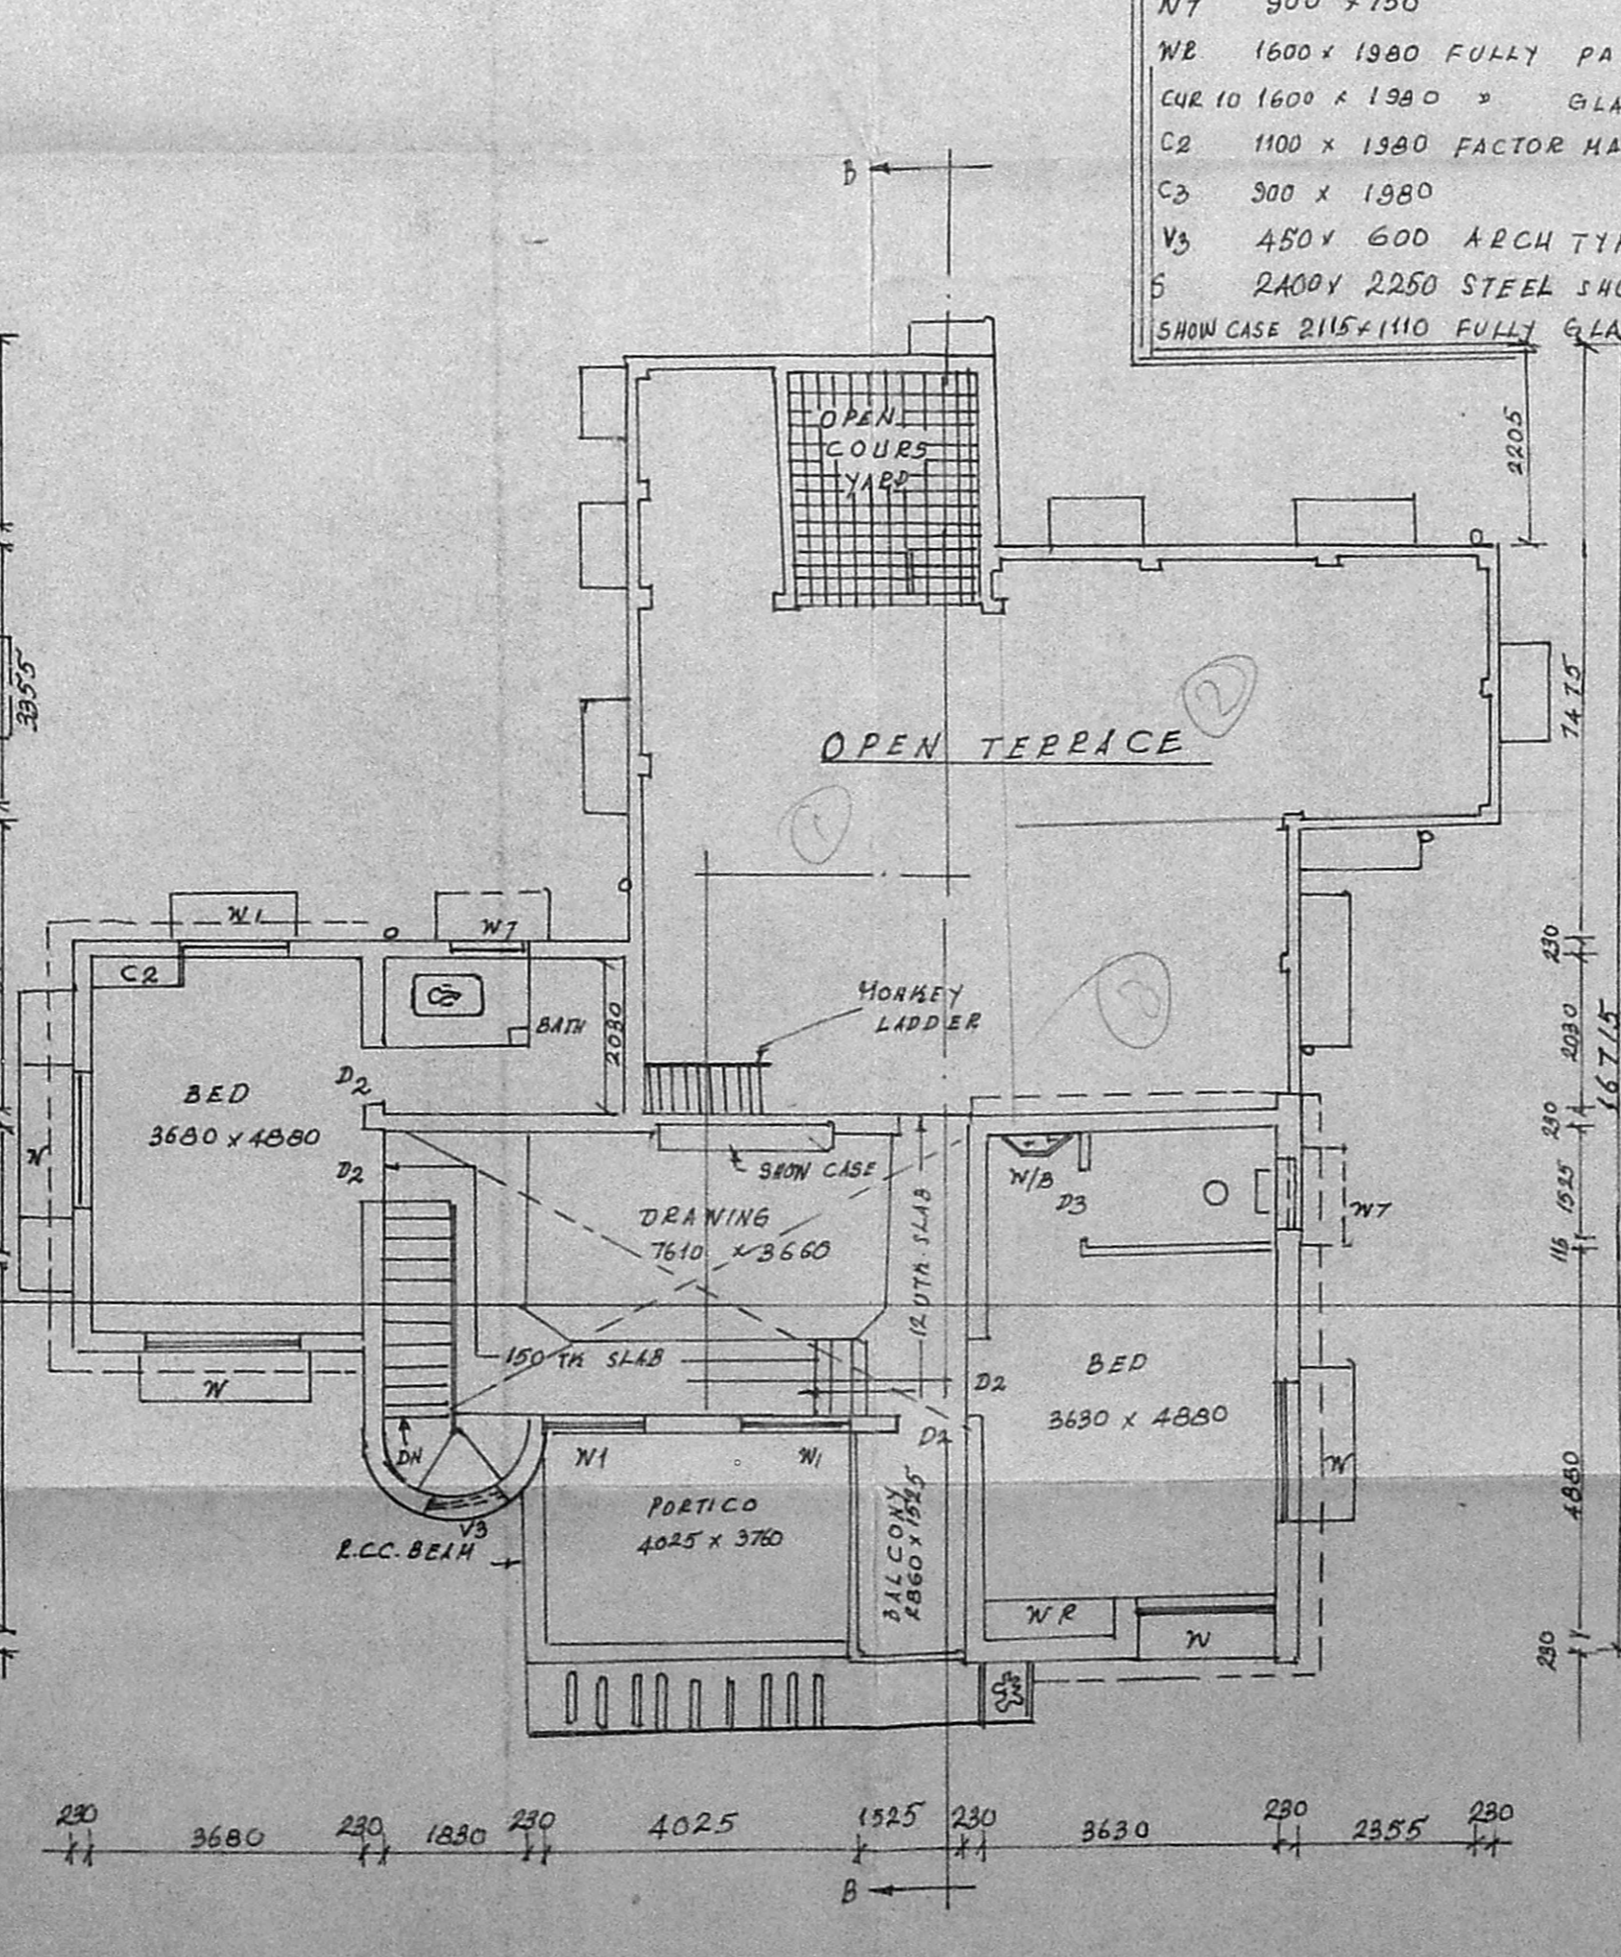


FIRST FLOOR PLAN

PLINTH AREA

GROUND FLOOR: 180.59 m²

FIRST FLOOR: 89.00 m²

TOTAL: 269.59 m²

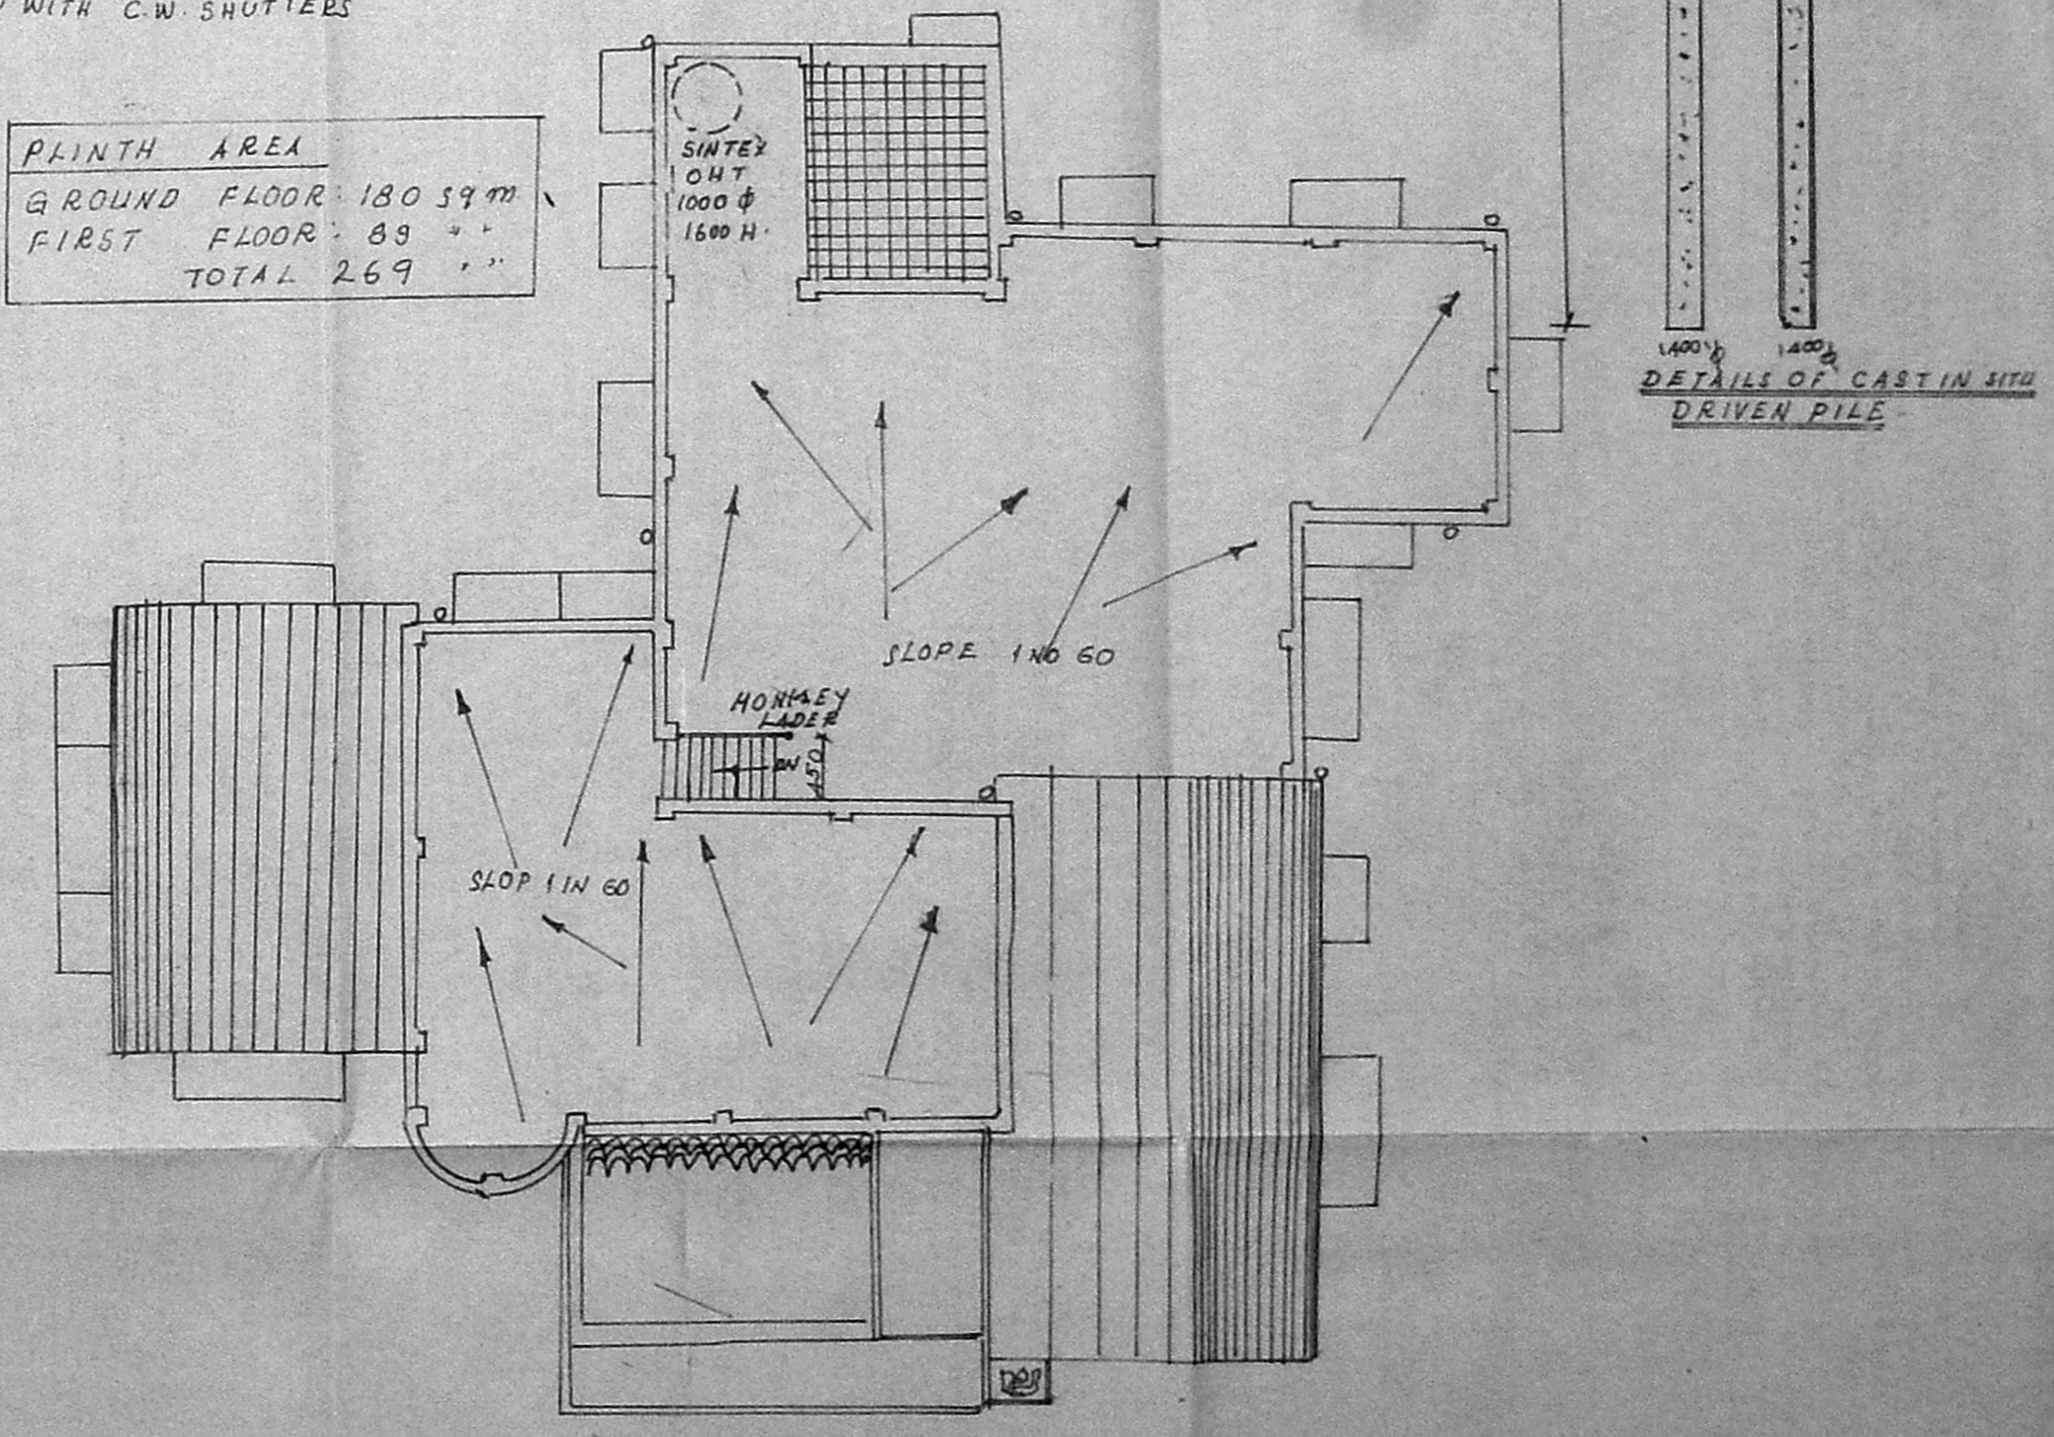

TERRACE PLAN

Superintending Engineer (Civil - II)

NORTH MADRAS THERMAL POWER PROJECT

ENNORE, MADRAS-37.

OWNER

S. SUBRAMANIAM, M. ARCH., A.I.I.

ARCHITECT AND INTERIOR DESIGNER

LICENCED CLASS-I, SURVEYOR NO. 11

8-11 VIDYARANYA, IIND MAIN ROAD

KAJURUVAHADI, ADYAR

MADRAS-600 020. TEL: 411335

DRAWN	TAMIL NADU ELECTRICITY BOARD	DRG NO.
CHECKED	NORTH MADRAS	
PASSED	THERMAL POWER PROJECT	DATE
TRACED	'Y' TYPE QUARTERS	SCALE: 1:100

DIMENSIONS GIVEN ARE IN M.M.